ATTACHMENT A

[Attachment A consists of 6 pages]

Develo	pment Plan Provisions - Consolidated 25 September 2014	
Land U	se	
Desired	Character Statement – Mid Suburban Policy Area 16	
	 This policy area will be characterised by a mix of dwelling types throughout, such as detached and semi-detached dwellings, interspersed with a range of well-designed medium density housing on larger, wider allotments as well as on main road frontages and facing larger public open spaces. It is desirable that dwellings be designed to complement and enhance the high quality pre and post-World War Two building styles and incorporating setback, siting, materials, roof forms and features consistent with and enhancing the established character. Development of detached and semi-detached dwellings up to two storeys in height is appropriate provided there is minimal overshadowing or overlooking of adjoining properties. Group dwellings and residential flat buildings are appropriate on larger, wider sites or those achieved through site amalgamation. 	Complies
Policy A	Area – Mid Suburban Policy Area 16	
01	Development that contributes to the desired character of the policy area.	Complies
PDC 1	Development should not be undertaken unless it is consistent with the desired character for the policy area.	Complies
Resider	itial Zone	A REAL PROPERTY OF SHIELD
01	A residential zone comprising a range of dwelling types	Complies
PDC 1	 The following forms of development are envisaged in the zone: Domestic outbuilding in association with a dwelling Domestic structure Dwelling Dwelling addition Small scale non-residential uses that serve the local community, for example: Child care facilities Health and welfare services Open space 	Complies
	 Primary and secondary schools 	

	o Recreation areas	
	 Shops, offices or consulting rooms 	
	Supported accommodation	
Visual A	ppearance/Built Form/Character	
Residen	tial Zone	States of the party of the party of
PDC 6	Development should not exceed two storeys in height except where specified in the relevant policy area.	Complies
PDC 7	The roof pitch of a dwelling should be less than 5 degrees and greater than 25.	Complies
General	Section- Design and Appearance	
01	Development of a high architectural standard that responds to and reinforces positive aspects of the local environment and built form.	Complies
PDC 1	 Buildings should reflect the desired character of the locality while incorporating contemporary designs that have regard to the following: (a) building height, mass and proportion (b) external materials, patterns, colours and decorative elements (c) roof form and pitch (d) façade articulation and detailing (e) verandas, eaves, parapets and window screens. 	Complies
Setback	s	
Resident	tial Zone	
PDC 14	Development should be consistent with the building envelope requirements as shown in the figure below, except where a variation to the building envelope is specified in a particular policy area:	Refer to report for discussion

	B B C C C C C C C C C C C C C	
	Section - Design and Appearance	
PDC 22	 Except in areas where a new character is desired, the setback of buildings from public roads should: (a) be similar to, or compatible with, setbacks of buildings on adjoining land and other buildings in the locality. (b) contribute positively to the streetscape character of the locality. 	Complies
PDC 23	 Except where specified in a particular Zone or Policy Area, development fronting the primary street (excluding verandahs, porches and similar) should be setback by either of the following distances (a) not less than the average of the setbacks of the adjoining buildings, if the difference between the setbacks of the adjoining buildings is greater than 2 metres (b) the same distance as one or the other of the adjoining buildings, provided the difference between the setbacks of the two adjoining buildings is less than or equal to 2 metres. 	Complies.
Oversha	dowing	
General	Section – Residential Development	
PDC 9	 The design and location of buildings should ensure that direct winter sunlight is available to adjacent dwellings, with particular consideration given to: (a) windows of habitable rooms, particularly living areas (b) ground-level private open space (c) upper-level private balconies that provide the primary open space area for any dwelling (d) access to solar energy. 	Complies.
PDC 10	Except where specified in a zone, policy area or precinct, development should ensure that: (a) north-facing windows to habitable rooms of existing dwelling(s) on the same allotment, and on adjacent allotments, receive at least 3 hours of direct sunlight over a portion of their surface between	Complies.

	 9 am and 3 pm on the 21 June. (b) ground level open space of existing buildings receives direct sunlight for a minimum of between 9 am and 3 pm on 21 June to at least the smaller of the following: (i) half of the existing ground level open space (ii) 35 square metres of the existing ground level open space (with at least one of the area' dimensions measuring 2.5 metres). (c) where overshadowing already exceeds the requirements contained in part (b), the area 	s
Crime Pr	overshadowed should not increase by more than 20 per cent.	
	Section – Crime Prevention	
PDC 2	Buildings should be designed to overlook public and communal streets and public open space to allow casual surveillance.	Complies.
General	Section - Transportation and Access	ALL THE TO A DEC TO A DEC
Vehicle F	Parking	
PDC 38	Development should provide off-street vehicle parking and specifically marked accessible car parking places to meet anticipated demand in accordance with <i>Table ChSt/2 – Off Street Vehicle Parking Requirements.</i>	Complies.
Private C	Open Space	
General S	Section – Residential Development	APRIL PORT
PDC 12	 Private open space (available for exclusive use by residents of each dwelling) should be provided for each dwelling and should be sited and designed: (a) to be accessed directly from the internal living areas of the dwelling (b) to be generally at ground level (other than for residential flat buildings) and to the side or rear of a dwelling and screened for privacy (c) to take advantage of, but not adversely affect, natural features of the site (d) to minimise overlooking from adjacent buildings (e) to achieve separation from bedroom windows on adjoining sites (f) to have a northerly aspect to provide for comfortable year round use (g) not to be significantly shaded during winter by the associated dwelling or adjacent 	Complies

	business activities with (j) to have sufficient ar	r air quality impacts that may a			
PDC 14	For each dwelling in the Re level, private open space s	esidential Zone or Residential Char hould: seable part, directly accessible from a	Refer to report for discussion		
	Policy area	Minimum area of useable private open space (square metres)	Minimum dimension (metres)	Maximum gradient	
	Integrated Medium Density Policy Area 20	16 - for a site area 250 square metres or less	4	1 in 10	
	Woodville Medium Density Policy Area 21	16 – for a site area 250 square metres or less	4	1 in 10	
		25 - for a site area greater than	4	1 in 10	
		250 square metres			
	Cheltenham Park Policy Area 22 and Woodville	250 square metres 10 – for a site area 250 square metres or less	3	1 in 10	
		10 - for a site area 250 square	3	1 in 10 1 in 10	

(c) be located behind(d) be provided at the		accordance with the	following require	ments	
	Detached dwelling Semi-detached dwelling Row dwelling	Group dwelling Residential flat building	Site area greater than 250 square metres	Site area 250 square metres or less	
Inner Suburban Policy Areas 15, Mid Suburban Policy Area 16, Western Edge Policy Area 17, West Lakes General Policy Area 18	25 per cent of the site area 20 per cent of the site area or 60 square metres per dwelling (whichever is the greater) where an allotment is adjacent or abuts a public road that is adjacent a coastal reserve or zone, the River Torrens Linear Park, the lake at West Lakes or a public reserve with an area of at least	80 square metres per dwelling or 25 per cent of the site area (whichever is the greater)			

ATTACHMENT B

[Attachment B consists of 16 pages]

 	>							
Ĩ	Development Applica	tion Form DA whom 20/1/15						
	Development Act 199.	3 Office Use Only						
	To submit an application, sections 1–15 of this application mu Please use block letters and black or blue pen. The completed accompanied by all required documents as specified in the pla requirements checklists and the applicable fees. Applications submitted that do not include the prerequisite in in the "Planning Requirements Checklist" will be returned for the applicant once they are complete.	st be completed. I form must be inning formation listed Received By:						
	1 Application Type:							
	Complying Development	Building Rules Consent (Building Only)						
	Development Plan Consent (Planning Only) includes approval to prune or remove a significant tree	Development Approval (Both Planning and Building)						
	2 Location of Proposed Development							
	No: 16_Street: FLEETWOOD CRES_Suburb: HENLEY BEACH Postcode: SOZZ							
	(or) Lot No: <u>66</u> DP: <u>9042</u> Section No: (Full/Part) Hd: Certificate of Title: Volume: <u>5436</u> Folio: <u>279</u>							
	B Detailed Description of Proposed Development DEMOLITION OF EXIST, RES #							
	SUB DIVISION DEVELP. INCL. Z NEW RES; I SIMALE & 12 STOREY.							
	Cost of the Proposed Development (excluding fit-out costs such as furniture)							
	\$ 500,000.00 Please note: Council may require written justification to verify costs.							
	5 Details of Parties Sections marked * must be completed.							
	(Please note that all correspondence will be addressed to the A applicants the addressee will be the first named) *Applicant Name (Mr/Mrs/Ms/Company): Astes BuiuDe							
	Email: admin @ aspenderigners. com							
	Postal Address: <u>z / 8 / Kink Killian</u> Phone: <u>81303700</u> Mobile:	<u>Fax:</u>						
	*Builder: <u>TBA</u>							
	Email:	······						
	Postal Address:							
	Phone: Mobile: *Owner(s) of Subject Land: (Mr/Mrs/Ms)							
	Email:							
	Postal Address:							
	Phone: Mobile:	Fax:						
		· · · · · · · · · · · · · · · · · · ·						

City of Charles Sturt 72 Woodville Road, Woodville, South Australia 5011 T 08 8408 1111 F 08 8408 1122 www.charlessturt.sa.gov.au

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6	Has The Construction Industry Training Fund Act 1993 Levy Been Paid?	Yes 🔲	No 🔀
7	Does a regulated tree exist on the site or on adjoining land which might be affected (including damage to tree roots) by the proposed development?	Yes 🔀	No 🗌

New Dwellings and Dwelling Additions (Sections 8 and 9 only)

8	Site Declarations - New Dwellings Only:	DIVISION.
8.1	Was the allotment created on or after 1 September 2009?	Yes 📄 No 🗌
8.2	Does the site have connection to or is capable of being connected to a sewage system or waste control system which complies with the Public and Environmental Health Act, 1987?	Yes 🔀 🛛 No 🕠
8.3	Was the site, to the best of your knowledge and belief, subject to site contamination as a result of a previous use of the land or a previous activity on the land?	Yes 🗌 No 🔀
9	Site Declarations – New Dwellings, Dwelling Additions and Carports	/Garages:
9.1	If the proposed building includes a garage/carport, does it gain	
5.2		f not applicable)
		f not applicable) Yes 🔲 No 🔀
	driveway access from:	
	driveway access from:(i9.1.1 an existing driveway or authorised access point; or	Yes 🗌 No 🔀

10 *Contact Person for Further Information (if other than the applicant)

Name: _	REMO NANNI 1	Arpex)	Email: reno. n@ aspecederigaers. Con.a.
Phone:	91303700	_ Mobile:	Fax:

11 Current Land and Property Use (e.g. dwelling, shop, industry, warehouse)

DWEL	124
Historic Use of Land	N/a
Are there any easements	
Are there any significant t	ees on the land or adjacent land? 🔀 Yes 🗌 No
is there a brush fence with proposed building work?	n 3 metres of the 🗌 Yes 🛛 No
Building classification o	
Building classification soug	t:la Present classification(s):(
Commercial/Industrial ap	
Number of employees:	Male: Female:
Institutional buildings:	Number of persons accommodated:
Assembly buildings:	Number of occupants:

13 Decision Notification Distribution

Decision Notices and associated documentation will be distributed by email if the applicants email address is included in the Applicant Details section on page 1 of this form. When distributing large size documents the decision documentation will be distributed via a downloadable link sent to your email unless a paper copy is specifically requested.

Please send a paper copy of the decision documentation by post.

14 Privacy policy

1

i acknowledge that copies of this application and supporting documentation may be provided to interested persons in accordance with the Development Regulations 2008 and Development Act 1993 and where public notification is required may be made available on Council's website. Information included within this application will be publicly available on Council's website within the Development Application Register and On Line Development Application Tracking system.

Details provided by the applicant, written representations and other technical reports form part of the reports attached to Council agendas. The agenda, minutes and accompanying report is made available on Council's website. Information, including names and addresses recorded in these documents can therefore be searched by the various website search engines.

15	*Signed:	Monos	(Ascex)	*Date:_	19/1.	15
	🔀 Appli	cant 🗌 Owne	er 🗌 Autl	norised Person		

16 Office Use Only:

Date:

Receipt No:

Demolition Prope	sal Form
completed development application form and	ing . For further details refer to the Development
1. Location of proposed development:	
(either) House No: 16 Street: FUETWOOD	0 CROS Suburb: HENLEY BEACH
	(Full/Part) Hd: Volume: 5436 Folio: 279
2. Description of building(s) to be demolished: tiled roof)	(eg: single storey brick veneer dwelling with concrete floor &
SINGLE STORET DURELING	TIMBOR PLOOR 4 TILED KOOF.
3. Demolition method	TIMBOR PLOOR 4 TILED KOOP.
	,
3. Demolition method	Demolition by explosives
Demolition method Hand demolition Mechanical demolition	Demolition by explosives
Demolition method Hand demolition Mechanical demolition	Demolition by explosives
 3. Demolition method And demolition And demolition And the molition And the m	
 3. Demolition method Hand demolition Mechanical demolition TBA \$ TO COMPY WITH 4. Describe the dust control method Works periodically sprayed with water TBA 	Demolition by explosives Demolition by explosives Other (provide details below) Other (provide details below)
 3. Demolition method And demolition And demolition And the molition And the m	Demolition by explosives Demolition by explosives Other (provide details below) Other (provide details below) Other (provide details below)
3. Demolition method □ Hand demolition □ Mechanical demolition □ TBA \$\frac{10}{10}\$ comply with 4. Describe the dust control method □ Works periodically sprayed with water □ TBA 5. Will the demolition directly impact on buildings on	Demolition by explosives Dother (provide details below)

7. Does the building contain asbestos?

Yes No Vinsure

City of Charles Sturt 72 Woodville Road, Woodville, South Australia 5011 T 08 8408 1111 F 08 8408 1122 www.charlessturt.sa.gov.au

8. Will the demolition include the removal of any significant trees from the site?

A significant tree is any tree which: has a trunk with a circumference of 2m or more (measured at 1m above natural ground level); or, in the case of trees with multiple trunks: has trunks with a total circumference of 2m or more and an average trunk circumference of 625mm or more (measured at 1m above natural ground level).

If yes, has a development application been lodged?

Yes	Π	No
109	L	IVV

5

🔲 Yes 🔀 No

8. Is the building to be demolisi	hed heritage listed?	
State heritage	N/A.	Local heritage
Contributory place	•	Other (provide details below)

Impact of Demolition on Rates for Your Land

If you are planning to demolish a residential property you may need to consider the timing of the demolition and the impact it will have on rates levied on the property.

For rating purposes, the City Of Charles Sturt rates vacant land at a much higher rate than residential land. The intention of this is to encourage development within the city.

For example: In the 2012/13 rating year, a property with a value of \$400,000 would pay

- a residential rate of \$1044.10 [plus the Natural Resources Management Levy], or
- a vacant land rate of \$3221.20 [plus the Natural Resources Management Levy]

The City of Charles Sturt determines rates levied based on land use supplied by the Valuer-General as at June 30 each year.

If demolition has proceeded and the land is rated vacant as at June 30 but a home will be built on the land during the coming financial year, there may be an opportunity to have the rates recalculated using the residential rate. If footings are poured by June 30 in that financial year and you can demonstrate that you intend to live in the home once built, you can apply to have your rates reviewed.

However, if you do not meet these criteria, that is, you are developing the land for investment purposes or to sell the residential property/ies to third parties, you will need to factor the increased rates into the cost of the development.

More information including application forms for rebates and Council's rating policy are available at the City of Charles Sturt website at <u>www.charlessturt.sa.gov.au</u>.

-	
	e
-1	BOD Title Desister Costal
ه ې	Title Register Search
1	LANDS TITLES OFFICE, ADELAIDE
	Issued pursuant to the Real Property Act 1886 and certified overleaf
•	
-1	REGISTER SEARCH OF CERTIFICATE OF TITLE * VOLUME 5436 FOLIO 279 *
"1	COST : \$15.50 (GST exempt) PARENT TITLE : CT 4330/930
1	REGION : GROUND FLOOR, L.T.O LGHP12 AUTHORITY : CONVERTED TITLE
	AGENT : GRFL BOX DO DATE OF ISSUE : 21/07/1997 SEARCHED ON : 07/04/2006 AT : 14:32:25 EDITION : 4
	SEARCHED ON : 07/04/2006 AI : 14:32(25 BDIIION : 4
-1	
7	REGISTERED PROPRIETOR IN FEE SIMPLE
	LEIGH ROBERT MERCIECA OF 16 PLEETWOOD CRESCENT HENLEY BEACH SA 5022
	DESCRIPTION OF LAND
1	ALLOTMENT 66 DREOSITED PLAN 9042 In the Area Named Henlby Beach
•	HUNDRED OF YATALA
•1	EASEMENTS
	SUBJECT TO THE EASEMENT OVER THE LAND MARKED B TO THE AUSTRALIAN &
1	OVERSEAS TELECOMMUNICATIONS CORPORATION LTD. (V 6446670)
_{	SCHEDULE OF ENDORSEMENTS
7	10104618 MORTGAGE TO ING BANK (AUSTRALIA) LTD.
J	
	NOTATIONS
	DOCUMENTS AFFECTING THIS TITLE
.,	*
"	NIL
1	

REGISTRAR-GENERAL'S NOTES

NIL


END OF TEXT.


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Page 1 of 2 The information appearing under notations has not been formally recorded in the Register Book and the provisions of the Real Property Act 1886 as to the conclusiveness of the Certificate overleaf do not extend thereto. Warning:

LANDS TITLES OFFICE ADELAIDE SOUTH AUSTRALIA DIAGRAM FOR CERTIFICATE OF TITLE VOLUME 5436 FOLIO 279 SEARCH DATE : 07/04/2006 TIME: 14:32:25

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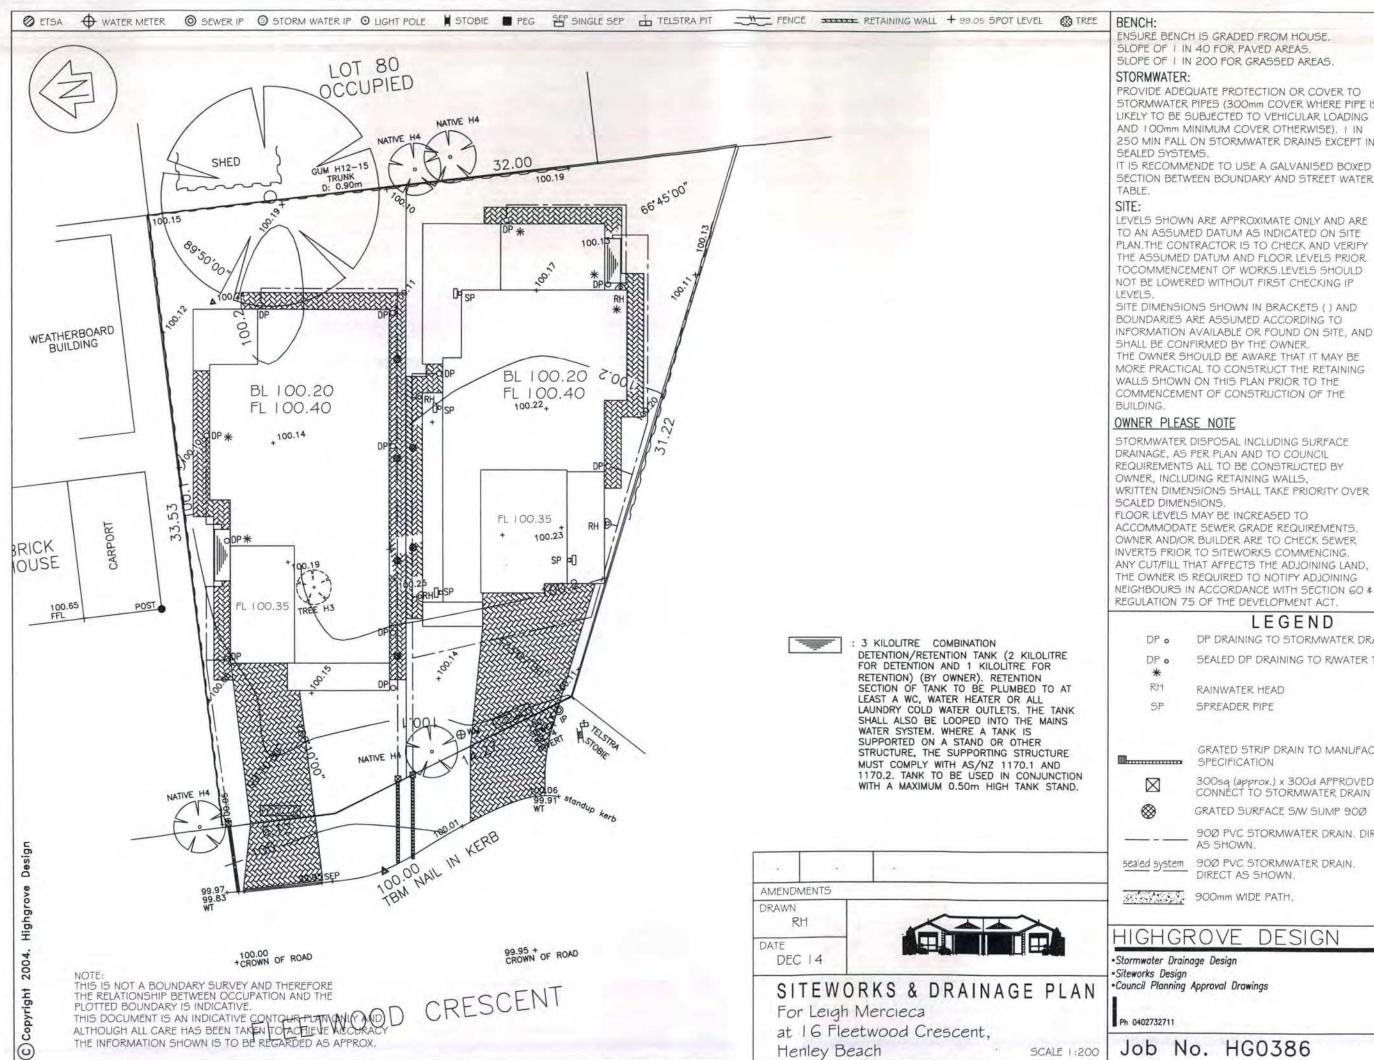
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Page 2 of 2

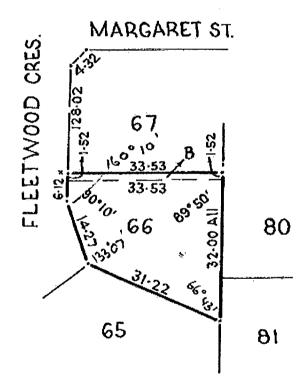

STORMWATER PIPES (300mm COVER WHERE PIPE IS LIKELY TO BE SUBJECTED TO VEHICULAR LOADING AND LOOmm MINIMUM COVER OTHERWISE). L IN 250 MIN FALL ON STORMWATER DRAINS EXCEPT IN

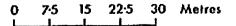SECTION BETWEEN BOUNDARY AND STREET WATER

LEVELS SHOWN ARE APPROXIMATE ONLY AND ARE TO AN ASSUMED DATUM AS INDICATED ON SITE PLAN. THE CONTRACTOR IS TO CHECK AND VERIFY THE ASSUMED DATUM AND FLOOR LEVELS PRIOR TOCOMMENCEMENT OF WORKS LEVELS SHOULD NOT BE LOWERED WITHOUT FIRST CHECKING IP

SITE DIMENSIONS SHOWN IN BRACKETS () AND BOUNDARIES ARE ASSUMED ACCORDING TO INFORMATION AVAILABLE OR FOUND ON SITE, AND THE OWNER SHOULD BE AWARE THAT IT MAY BE MORE PRACTICAL TO CONSTRUCT THE RETAINING COMMENCEMENT OF CONSTRUCTION OF THE

STORMWATER DISPOSAL INCLUDING SURFACE REQUIREMENTS ALL TO BE CONSTRUCTED BY WRITTEN DIMENSIONS SHALL TAKE PRIORITY OVER

ACCOMMODATE SEWER GRADE REQUIREMENTS. OWNER AND/OR BUILDER ARE TO CHECK SEWER INVERTS PRIOR TO SITEWORKS COMMENCING. ANY CUT/FILL THAT AFFECTS THE ADJOINING LAND. THE OWNER IS REQUIRED TO NOTIFY ADJOINING NEIGHBOURS IN ACCORDANCE WITH SECTION 60 \$


LEGEND

DP o	DP DRAINING TO STORMWATER DRAIN.
DP o *	SEALED DP DRAINING TO RWATER TANK.
RH	RAINWATER HEAD
SP	SPREADER PIPE
	GRATED STRIP DRAIN TO MANUFACTURERS

300sg (approx.) x 300d APPROVED SUMP. CONNECT TO STORMWATER DRAIN U.N.O. GRATED SURFACE SAV SUMP 900

900 PVC STORMWATER DRAIN, DIRECT

Rev

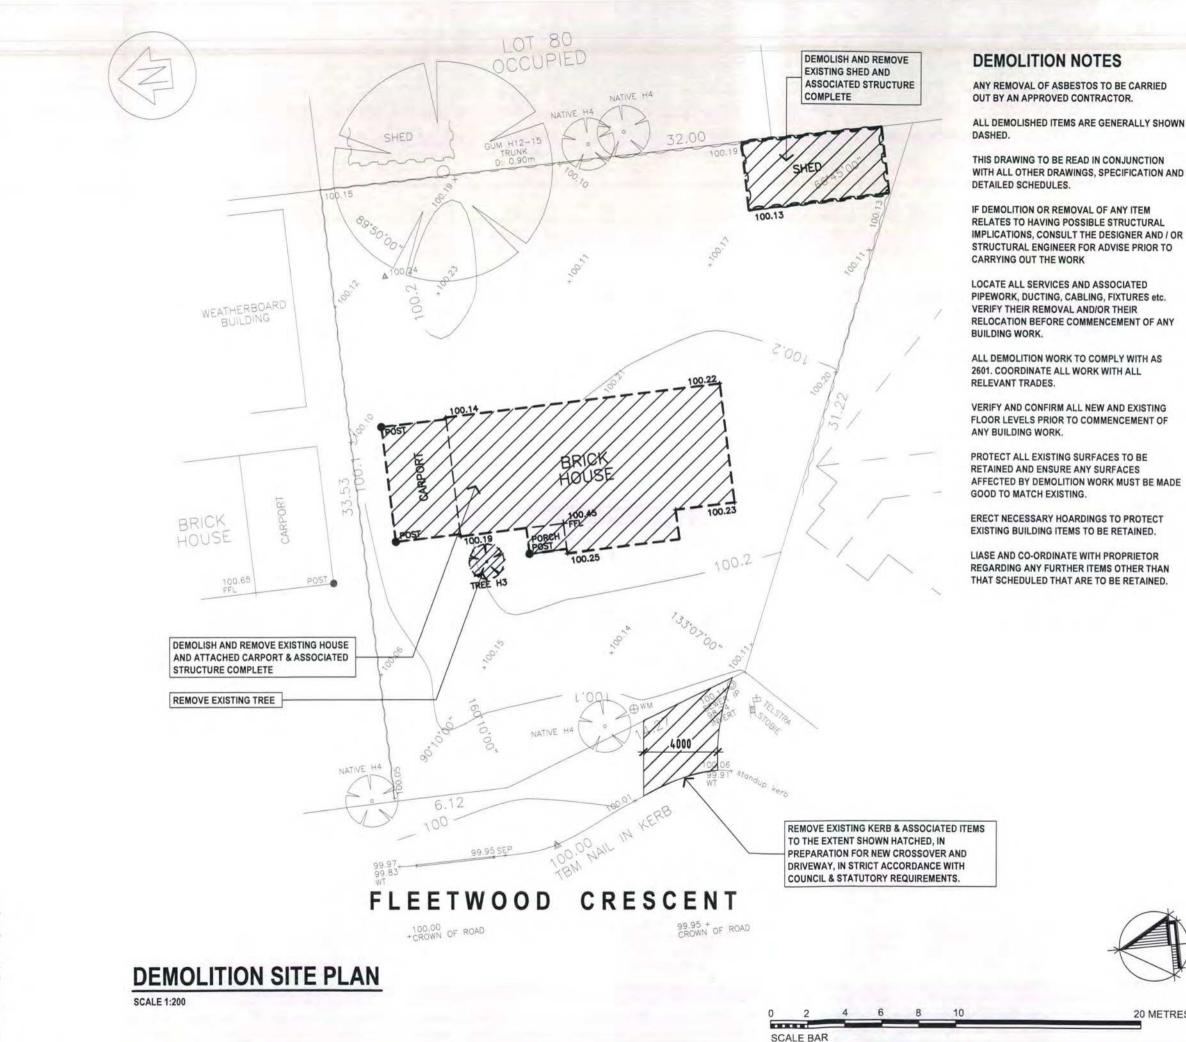

20 METRES


HATCH DENOTES EXTENT OF **EXISTING BUILDINGS & OUT** BUILDINGS TO BE DEMOLISHED

DEMOLITION LEGEND:



DENOTES DEMOLITION AND OR REMOVAL OF ITEMS, THIS DRAWING TO BE READ IN-CONJUNCTION WITH ALL OTHER ASSOCIATED DRAWINGS.

DENOTES EXISTING TREES TO BE REMOVED

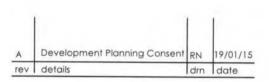



ASPEX BUILDING DESIGNERS Pty Ltd 2/81 King William Street Kent Town SA 5067 08 8130 3700

> admin@aspexdesigners.com.au www.aspexdesigners.com.au

> > ABN 73 090 085 037

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project **PROPOSED SUBDIVISION** DEVELOPMENT

address

ONSENT

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PLANNIN

EVELOPMENT

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16 Fleetwood Cres., Henley Beach, SA client

Leigh Mercieca sheet size A3

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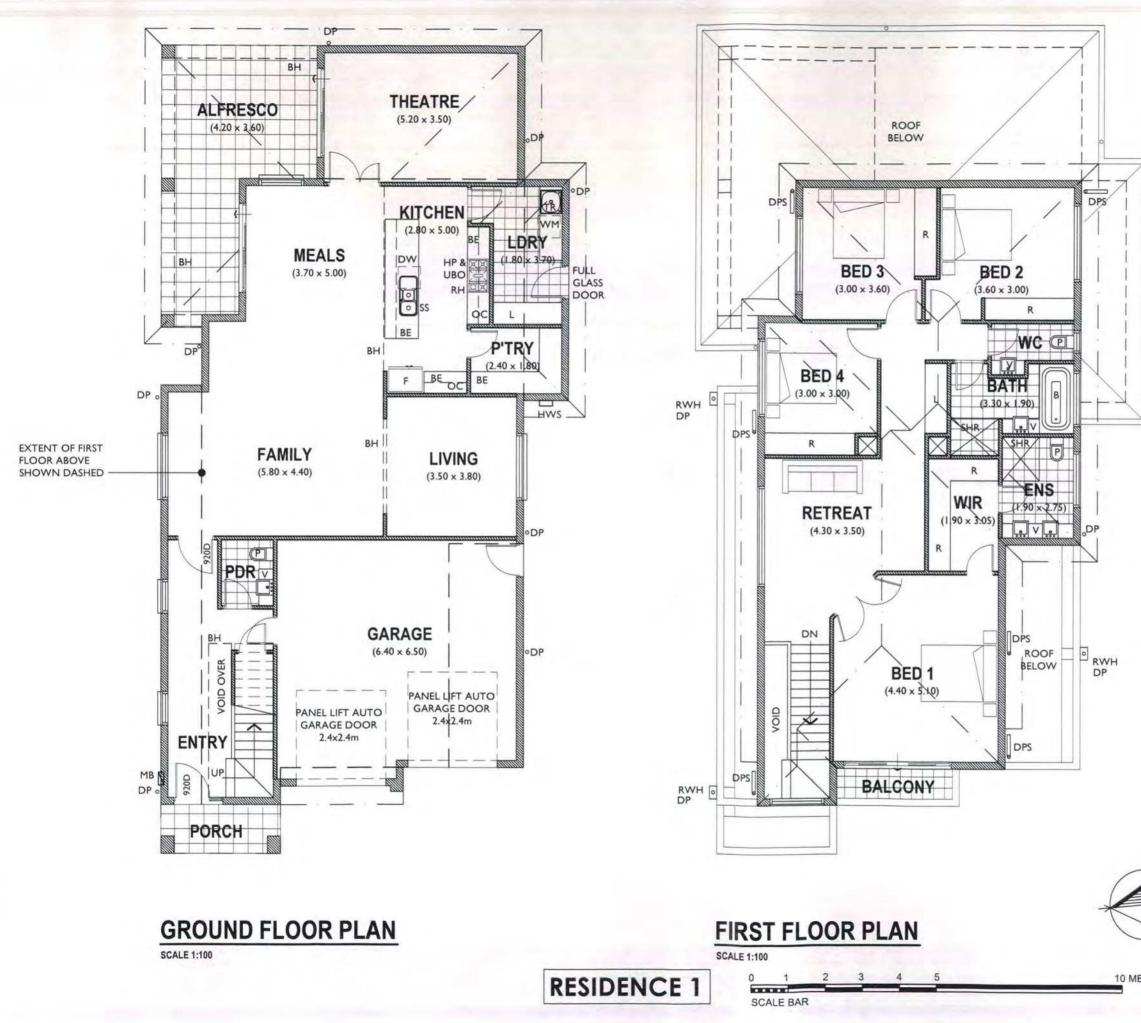
drawn RN

drawing title **DEMOLITION SITE PLAN**

project no **MER 2942**

drawing no PD01

revision no A



LEGEND

Ρ	TOILET PAN	
v	VANITY BASIN WITH ASSOCIATED JOINERY UNIT	
SHR	SHOWER	
В	BATH	
F	REFRIGERATOR	
DW	DISHWASHER	
SS	STAINLESS STEEL SINK	
HP & UBO	HOT PLATE (GAS) & UNDER BENCH OVEN	
RH	RANGE HOOD VENTED TO ATMOSPHERE	
oc	OVERHEAD CUPBOARD	
WIR	WALK IN ROBE	
R	ROBE	
L	LINEN	
BE	BENCH	
WM	WASHING MACHINE	
TR	INSET TROUGH	
BH	BULKHEAD OVER AT 2400AFL	
DP	90mm DIAM. PAINTED UPVC DOWNPIPE	
DPS	DOWNPIPE & SPREADER	
RWH	SELECTED COLORBOND RAINWATER HEAD WITH OVERFLOW OUTLET	
	DENOTES SELECTED CERAMIC FLOOR TILES	
MB	METER BOXES	
HWS	HOT WATER SYSTEM (GAS)	
1	1.1	

	Development Planning Consent	DNI	19/01/15
~	bereiephien Hanning eensem	RIN	17/01/15
rev	details	drn	date



building designers

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project PROPOSED SUBDIVISION DEVELOPMENT

A3

CONSENT

PLANNING

DEVELOPMENT

address 16 Fleetwood Cres., Henley Beach, SA client

Leigh Mercieca

sheet size

scale 1:100

drawn RN

revision no


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drawing title RESIDENCE 1 - FLOOR PLANS project no

MER 2942

drawing no PD03 10



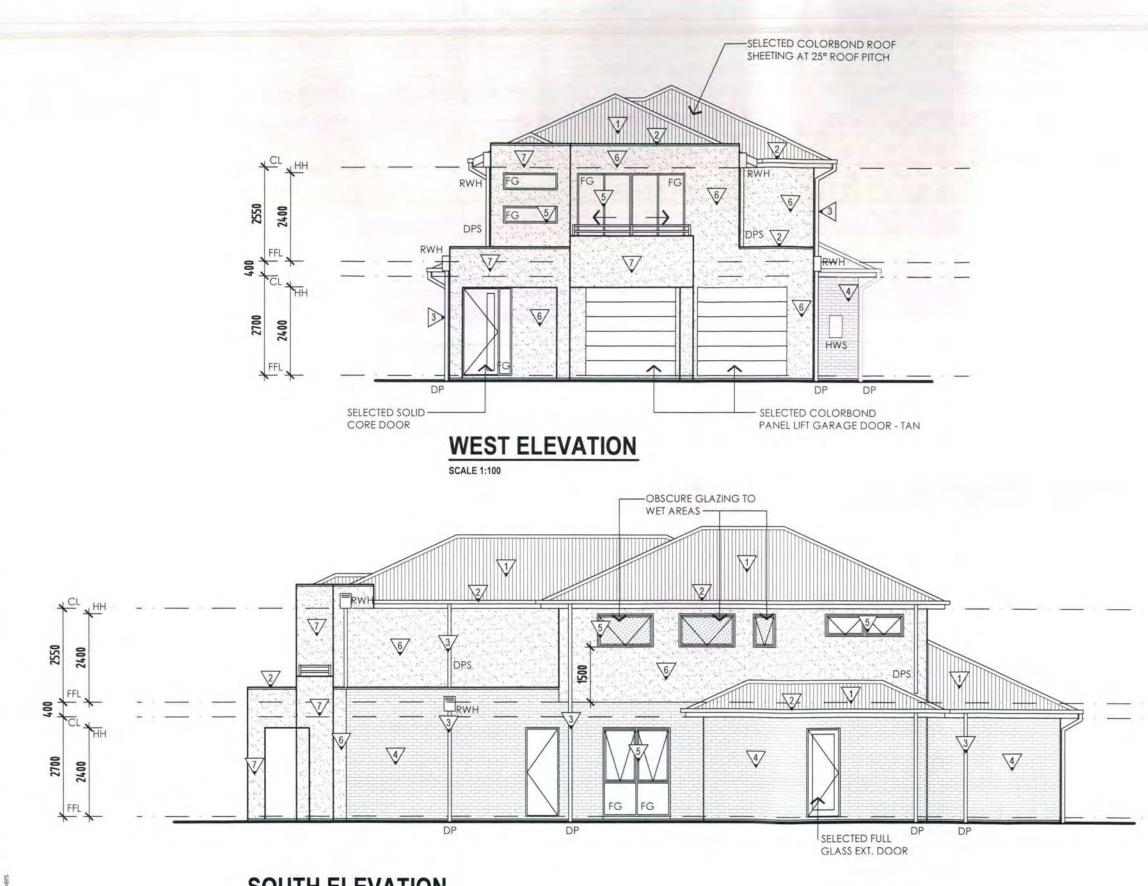

SOUTH ELEVATION

..... SCALE BAR

ELEVATIONS LEGEND:

CL	CEILING LEVEL
FFL	FINISHED FLOOR LEVEL
DP	90mm DIAM. PAINTED UPVC DOWNPIPE
DPS	DOWNPIPE AND SPREADER
FG	FIXED GLASS
MB	METER BOXES
нн	HEAD HEIGHT
HWS	HOT WATER SYSTEM
RWH	SELECTED COLORBOND RAINWATER HEAD WITH OVERFLOW OUTLET

EXTERNAL FINISHES:

\forall	SELECTED COLORBOND ROOF SHEETING AT 25° ROOF PITCH - BLACK				
2/	SELECTED COLORBOND FASCIAS, GUTTERS & PARAPET CAPPINGS - BLACK				
3/	SELECTED COLORBOND DOWNPIPES - CREAM / BEIGE				
\checkmark	SELECTED FACE BRICKWORK TO EXTERNAL WALL - CREAM / BEIGE / TAN				
5	SELECTED POWDERCOATED ALUMINIUM - WINDOWS & SLIDING GLASS DOORS - BLACK				
6	SELECTED ACRYLIC RENDER - LIGHT TAN				
$\overline{\mathbb{V}}$	SELECTED ACRYLIC RENDER - DARK TAN				
A	Development Planning Consent RN 19/01/15				



drn date

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building designers

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project PROPOSED SUBDIVISION DEVELOPMENT

address

CONSENT

DEVELOPMENT PLANNING

rev details

16 Fleetwood Cres., Henley Beach, SA client

Leigh Mercieca

sheet size A3

scale 1:100 drawn RN

revision no

A

drawing title RESIDENCE 1 - ELEVATIONS 1 OF 2 project no

MER 2942

drawing no PD04 11



SCALE 1:100

RESIDENCE 1

..... SCALE BAR 3

4

ELEVATIONS LEGEND :

CL	CEILING LEVEL
FFL	FINISHED FLOOR LEVEL
DP	90mm DIAM. PAINTED UPVC DOWNPIPE
DPS	DOWNPIPE AND SPREADER
FG	FIXED GLASS
MB	METER BOXES
нн	HEAD HEIGHT
HWS	HOT WATER SYSTEM
RWH	SELECTED COLORBOND RAINWATER HEAD WITH OVERFLOW OUTLET

EXTERNAL FINISHES:

\forall	SELECTED COLORBOND ROOF SHEETING AT 25° ROOF PITCH - BLACK				
2/	SELECTED COLORBOND FASCIAS, GUTTERS & PARAPET CAPPINGS - BLACK				
3	SELECTED COLORBOND DOWNPIPES - CREAM / BEIGE				
4	SELECTED FACE BRICKWORK TO EXTERNAL WALL - CREAM / BEIGE / TAN				
5	SELECTED POWDERCOATED ALUMINIUM - WINDOWS & SLIDING GLASS DOORS - BLACK				
6	SELECTED ACRYLIC RENDER - LIGHT TAN				
$\overline{\mathbb{V}}$	SELECTED ACRYLIC RENDER - DARK TAN				
A	Development Planning Consent RN 19/01/15				



rev details

ASPEX BUILDING DESIGNERS Pty Ltd 2/81 King William Street Kent Town SA 5067 08 8130 3700

> admin@aspexdesigners.com.au www.aspexdesigners.com.au

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project PROPOSED SUBDIVISION DEVELOPMENT

address 16 Fleetwood Cres., Henley Beach, SA client

Leigh Mercieca sheet size A3

scale 1:100 drawn RN

drn date


drawing title RESIDENCE 1 - ELEVATIONS 2 OF 2

project no MER 2942

drawing no PD05 12 A

revision no

CONSENT DEVELOPMENT PLANNING

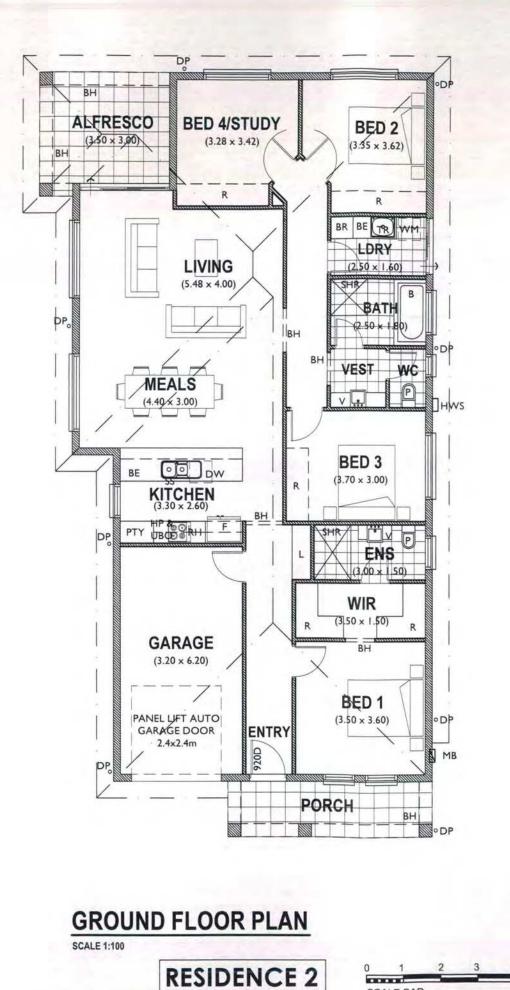



..... SCALE BAR

LEGEND

Ρ	TOILET PAN			
v	VANITY BASIN WITH ASSOCIATED JOINERY UNIT			
SHR SHOWER				
в	BATH			
F	REFRIGERATOR			
DW	W DISHWASHER			
SS	STAINLESS STEEL SINK			
HP & UBO	& HOT PLATE (GAS) & UNDER			
RH	RANGE HOOD VENTED TO ATMOSPHERE			
oc	OVERHEAD CUPBOARD			
WIR	WALK IN ROBE			
R	ROBE OR ROBE LOCATION	ROBE OR ROBE LOCATION		
L	LINEN			
BE	BENCH	BENCH		
BR	BROOM			
WM	WASHING MACHINE			
TR	INSET TROUGH			
BH	BULKHEAD OVER AT 2400A	FL		
DP	90mm DIAM. PAINTED UPVC	DO	WNPIPE	
DPS	DOWNPIPE & SPREADER			
RWH	SELECTED COLORBOND RAINWATER HEAD WITH OVERFLOW OUTLET			
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MB	METER BOXES			
hws I	HOT WATER SYSTEM (GAS)	1	Г	
A	Development Planning Consent	RN	19/01/15	
rev	details	drn	date	



ASPEX BUILDING DESIGNERS Pty Ltd 2/81 King William Street Kent Town SA 5067

08 8130 3700

admin@aspexdesigners.com.au www.aspexdesigners.com.au

ABN 73 090 085 037

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project PROPOSED SUBDIVISION DEVELOPMENT

address

A3

CONSENT

PLANNING

DEVELOPMENT

16 Fleetwood Cres., Henley Beach, SA client

Leigh Mercieca

sheet size

scale 1:100


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drawing title RESIDENCE 2 - FLOOR PLAN PD06 13 A project no

MER 2942





ELEVATIONS LEGEND:
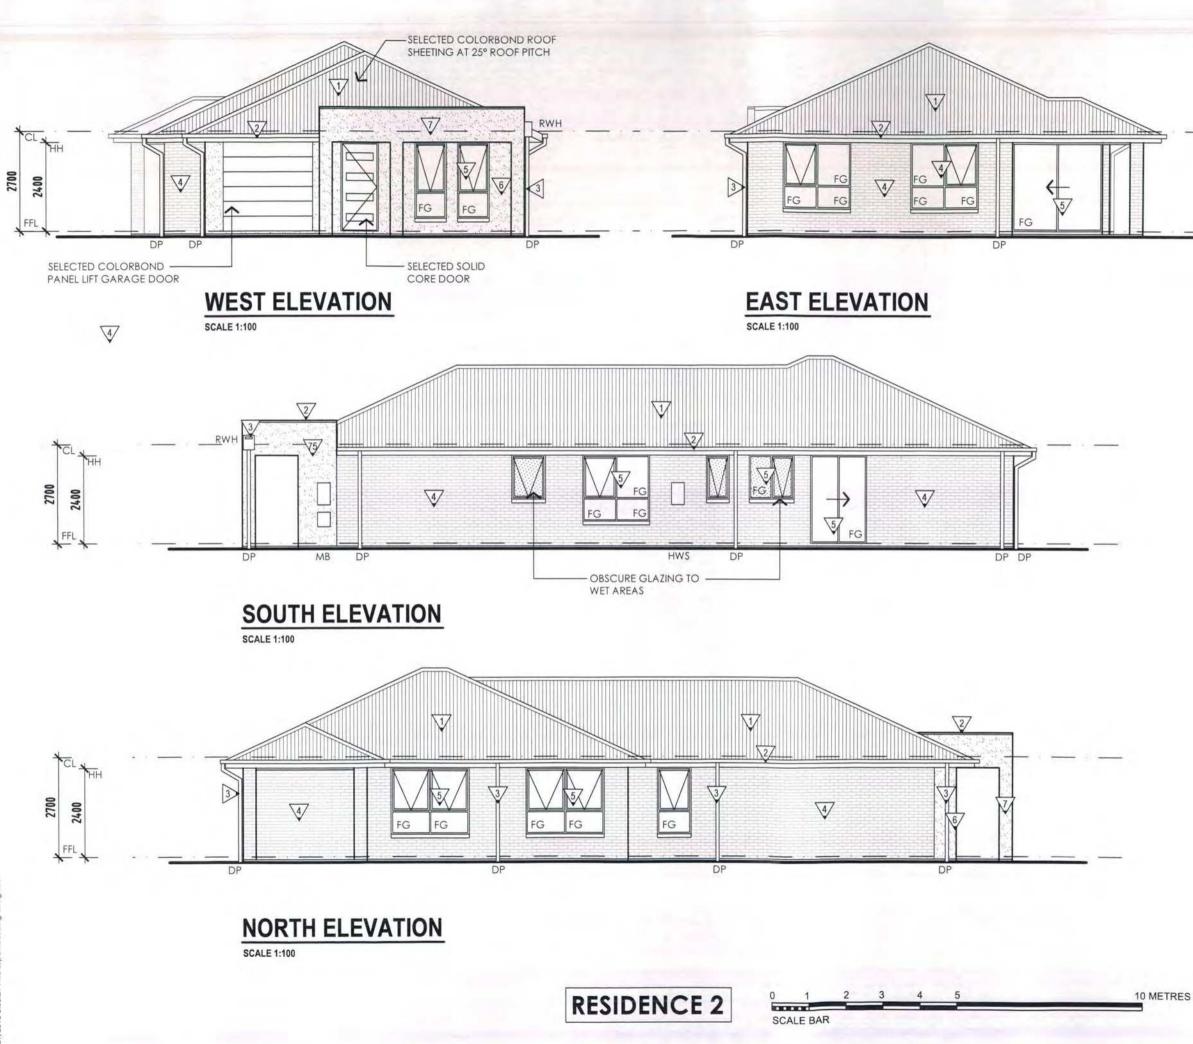
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FINISHED FLOOR LEVEL
90mm DIAM. PAINTED UPVC DOWNPIPE
DOWNPIPE AND SPREADER
FIXED GLASS
METER BOXES
HEAD HEIGHT
HOT WATER SYSTEM
SELECTED COLORBOND RAINWATER HEAD WITH OVERFLOW OUTLET

EXTERNAL FINISHES:

∇	SELECTED COLORBOND ROOF SHEETING
¥	AT 25° ROOF PITCH - BLACK

- SELECTED COLORBOND FASCIAS, 2/ GUTTERS & PARAPET CAPPINGS - BLACK
- 3 SELECTED COLORBOND DOWNPIPES - CREAM / BEIGE
- SELECTED FACE BRICKWORK TO 4 EXTERNAL WALL - CREAM / BEIGE / TAN
- SELECTED POWDERCOATED ALUMINIUM -5 WINDOWS & SLIDING GLASS DOORS - BLACK
- 6 SELECTED ACRYLIC RENDER - LIGHT TAN
- 77 SELECTED ACRYLIC RENDER - DARK TAN

Development Planning Consent RN 19/01/15 A rev details drn date



building designers

ASPEX BUILDING DESIGNERS Pty Ltd 2/81 King William Street Kent Town SA 5067 08 8130 3700

> admin@aspexdesigners.com.au www.aspexdesigners.com.au

> > ABN 73 090 085 037

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project PROPOSED SUBDIVISION DEVELOPMENT

address 16 Fleetwood Cres.,

Henley Beach, SA client

Leigh Mercieca sheet size

scale 1:100 drawn RN

drawing title **RESIDENCE 2 - ELEVATIONS** project no drawing no

MER 2942


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detailed survey <u>only</u>. Prior to any building work commencing, It is the builder's responsibility to arrange a Boundary

rev	details	drn	date
Α	Development Planning Consent	RN	19/01/15
В	Council note re easement	RN	13/02/15
С	Extra Boundary Dimensions & Site areas shown	RN	27/03/15

MER 2942

16 PD02

City of Charles Sturt
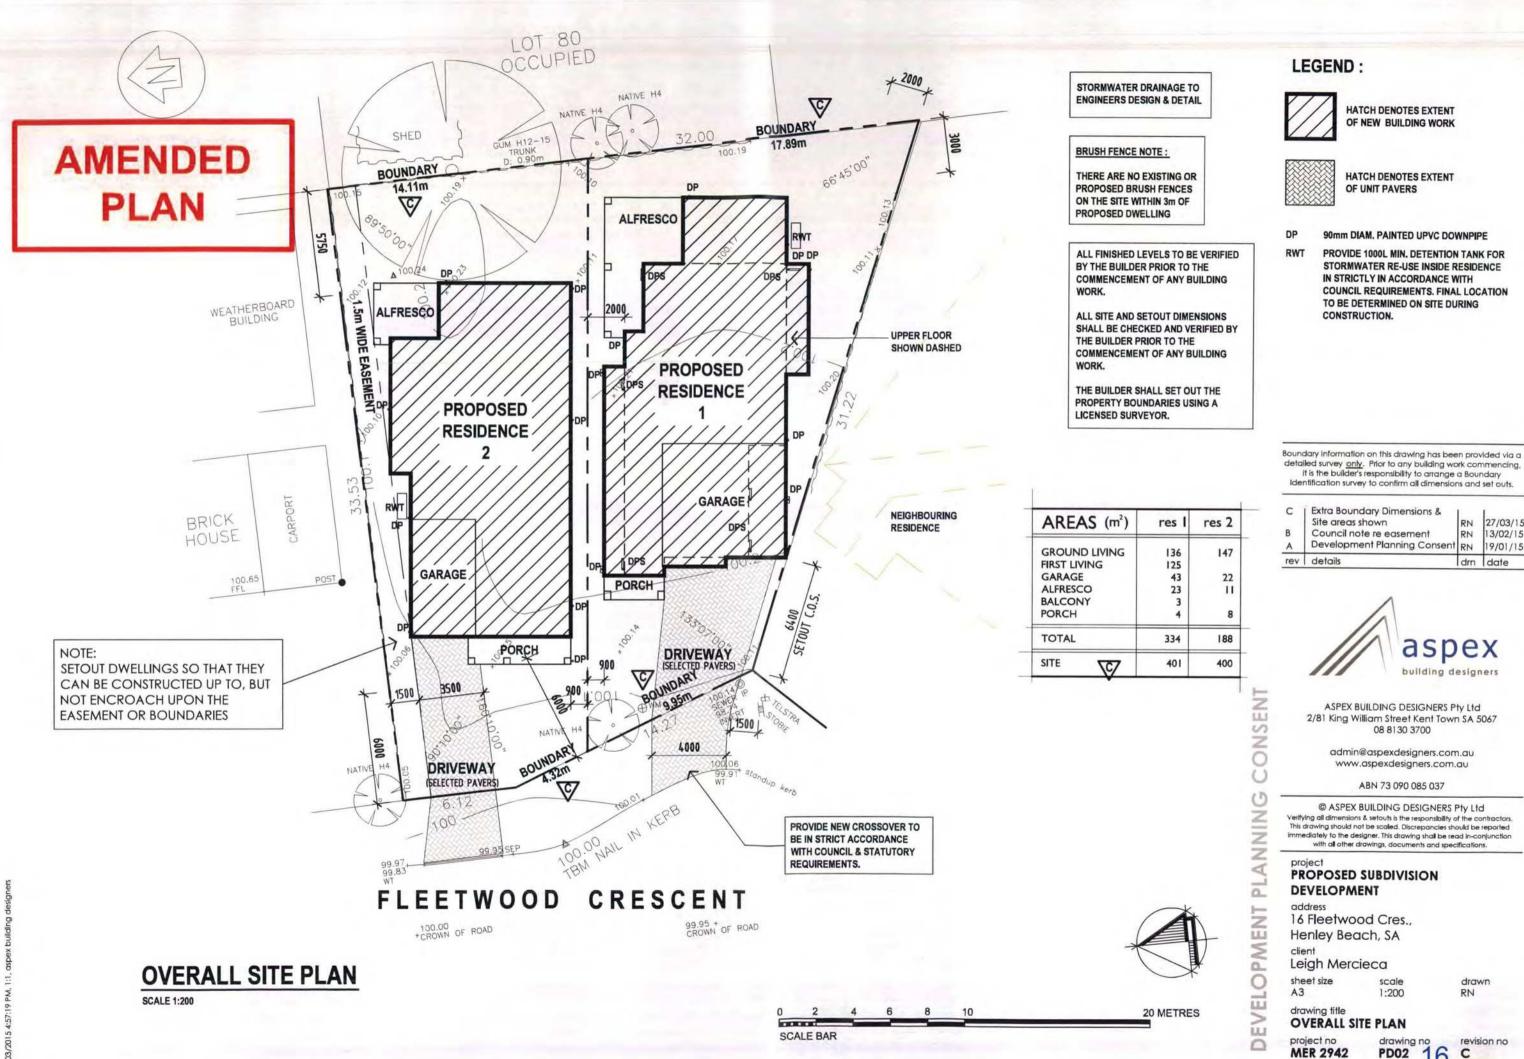
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ATTACHMENT C

[Attachment C consists of 11 pages]

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5 Statement of Representation Pursuant to Section 38 of the Development Act 1993

Under the Development Act 1993, any person may, in accordance with the regulations, make a representation in writing to the relevant authority in relation to the granting or refusal of consent for a Category 2 or Category 3 development application. To submit a statement of representation please complete ALL <u>9</u> sections of this form and send to council.

Please note that pursuant to section 38(17) of the Development Act 1993, if the application involves a Category 2 notification and you were not entitled to receive notice of the application in accordance with the Development Act 1993 and Development Regulations 2008 you cannot make a representation in relation to the application.

*1. Development Number 252 / 0167 / 15 17 Kimi 200
House No: 16 Street: FLEETWOOD CROCERT CHARLES STILL
Suburb: Henley Beech
*2. Person(s) making representation:
Name: (Mr/Mrs/Ms) CL KAPLANIS
Name: (Mr/Mrs/Ms) <u>C</u> L (CAT LATER Street Address: 18 Fleetwood Crescent Henley Beach
Postal Address (if different to above):
Email: M. agar @ adam.con.au
Email: M. agar @ adam.con.au Phone: 8355 6076 Mobile: 041984721 Fax:
*3. Please indicate whether you wish to personally present your statement to the Development Assessment Panel. Your written statement will be provided to the Development Assessment Panel and to the applicant, and will be considered in making an approval decision. You may choose to present your statement verbally.
Please tick one of the boxes below
I do not wish to make a verbal presentation.
I will appear personally to make a verbal presentation.
XI authorise <u>TICHAEL</u> AGAR to make the verbal representation on my behalf
*4. Nature of interest in development (eg adjoining resident, owner of land in vicinity or on behalf of organisation or company):
OWN+LIVE next door to "development"
*5. Issues that I/we would like to raise: h_{1}

dwellin ۱.

*6. These issues would be overcome by (state action sought):

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Speed restriction / speed humas	
NO on-street " janting"	
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*7. I would like an officer of Council to contact me to discuss my submission Yes 🗹 No 🗆

*8. I would like to meet with the applicant to discuss my submission	Yes 🖸	No
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*9. Privacy

I acknowledge that copies of this representation and supporting documentation may be provided to interested persons in accordance with the Development Regulations 2008 may be made available on Council's website.

Written representations form part of the reports attached to Council agendas. The agenda, minutes and accompanying report is made available on Council's website. Information, including names and addresses recorded in these documents can therefore be searched by the various website search engines.

Date: 16-3-15 Authorised by (insert name): ALL 9 Sections of this form must be completed.

Representations

Representations must be made in writing, and a Statement of Representation form must be completed and supplied. The Statement of Representation form requires persons making a representation to state their name and address, and describe the reasons for their representation and how the issues would be overcome.

The written statement is more likely to be effective if it refers to the provisions of The Charles Sturt Development Plan this can be accessed at the City of Charles Sturt website, <u>www.charlessturt.sa.gov.au</u>

Copies of representations are forwarded to the applicant, and the applicant is given the opportunity to respond in writing to the representation.

It is not necessary to attend a Development Assessment Panel meeting, but you may chose to do so to make a verbal presentation of your concerns. Please note that the time for making a verbal presentation will be limited to approximately 5 minutes.

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Council advises Representors with notice of its decision. In the case of a Category 3 development, Representors have the right to lodge an appeal against the decision with the Environmental Resource and Development Court.

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TO: City of Charles Sturt PO Box 1 Woodville 5011

Re: 252/0167/15

Dear Sir,

I refer to development application concerning 16 Fleetwood Crescent, which is next door to my residence.

I do not wish to see 2 storey dwellings erected, as they are unsightly, out of character, and give too much view of neighbouring back yards.

I am more concerned by the traffic issues.

Fleetwood Crescent has a park, which contains playground equipment, and children use this park very often.

The "development" proposed is, essentially, building two dwellings where one exists now.

This is not novel, and the proportion of blocks in this street and adjoining, split into two blocks, is now approaching 50% of available blocks.

Each of the newly created "double blocks" always seems to have 2 car ports, and 2 cars.

This has resulted in a considerable increase in traffic.

Not all of these drivers are careful. Some speed.



Many vehicles, including trucks, are left "parked" on the road, often for days or weeks.

This causes visibility problems.

Children are moving in and out from behind large parked cars and trucks whilst multiple vehicles speed past.

There is a significant statistical chance of a child being injured or killed by this situation.

This could be reduced by not granting any more development applications involving "splitting" existing blocks.

It could also be reduced by banning on street parking.

It could be reduced by preventing on street "permanent" parking by creating a time limit [1 hour?] and enforcing it.

It could also be reduced by creating a 25 kilometre/hour speed limit.

The 25 kilometre/hour speed limit outside the nearby school is largely ineffective, as only the careful drivers observe the speed limit, and the police do not enforce it.

Speed humps are difficult to ignore, and at least 4 should be installed, one at each entrance to Fleetwood Crescent and one at the beginning and end of the road way where the park starts and ends.

I therefore ask for a signed 25 kilometre/hour speed limit on the whole of Fleetwood Crescent, together with speed humps – probably at least 4.

4 < -

In this way the increased danger to children being killed and injured can be reduced.

I do not wish to meet with the applicants, as I understand that the owners wish to make money by way of the subdivision, and will view any objection with hostility.

I do not wish to stop the owners making money, but I do fear for the safety of children living near here and playing in the park.

If the new owners of these 2 dwellings have children, then their children will be at increased risk of death and injury unless this narrow road is cleared of sight obstructions and slowed down.

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Claire Kaplanis 18 Fleetwood Crescent Henley Beach 5022 8355 6076 or 0419847211 or magar@adam.com.au

5 Statement of Representation Pursuant to Section 38 of the Development Act 1993

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*1. Development Number	252 / 0167	115		. 1 3 MAR. 20	M5
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	y BEACH 3				
*2. Person(s) making repre			L		
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	to above): 1 TUDOR			7-2011=23	5024
Email:				SPARNUNS	3007
	Mobile: 040	1815407	Fax:		•
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Please tick one of the bo	oxes below				
🔀 I do not wish to make a	verbal presentation.				
I will appear personally	to make a verbal presentation.				
I authorise	to make	e the verbal repres	entation on	my behalf	
*4. Nature of interest in de- behalf of organisation o	velopment (eg adjoining resider r company):	nt, owner of land-in	n vicinity or	on	
ADJOINING	Residence				
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ME REGARDING REMOVAL OF GARAGE	on Be	SUNDARY
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Will ConnorCE.	-	/
*7. I would like an officer of Council to contact me to discuss my submission	Yes 🛛	No 🕑
*8. I would like to meet with the applicant to discuss my submission	Yes 🛛	No M

*9. Privacy

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7

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2. Person(s) making representation: ame: (<i>Mr/Mrs/355) <u> </u></i>	
treet Address: 27 MITTON AVE	HENCEY BEACH SA
Postal Address (if different to above):	
Email:	
Phone: (08) 83561900 Mobile:	Fax:
*3. Please indicate whether you wish to personally present yo Assessment Panel. Your written statement will be provided and to the applicant, and will be considered in making an ap present your statement verbally.	to the Development Assessment Panel oproval decision. You may choose to
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*6. These issues would be overcome by (state action sought):

COMPLIANCE WITH EXISTING BY-LAWS/REGUL	ATIONS	ETC
*7. I would like an officer of Council to contact me to discuss my submission	Yes 🗆	No 🗹
*8. I would like to meet with the applicant to discuss my submission	Yes 🗖	No D

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Authorised by (insert name): M 4 R TIERNE

Date: 17032015

ALL 9 Sections of this form must be completed.

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30th March 2015

Leah Wojtkowski Development Officer City of Charles Sturt PO Box 1 Woodville SA 5071

Our Ref: MER 2942 Development Number: 252/0167/15

Dear Leah,

Re: RESPONSE TO REPRESENTATIONS FOR DA 252/0167/15 LOCATED AT 16 FLEETWOOD CRESCENT, HENLEY BEACH SA 5022.

We write in response to your letter dated 20th March 2015 and the representations received during public notification of the above mentioned development application.

We have been provided with a total of three (3) representations made by:

- Mrs. Claire Kaplanis (18 Fleetwood Crescent, Henley Beach)
- Mr. Sergio Facchin (25 Mitton Avenue, Henley Beach)
- Mr. & Mrs. M & R Tierney (27 Mitton Avenue, Henley Beach)

In summary, the key issues raised by representors relate to the following:

- Two storey height
- Privacy and overlooking
- Development of one single allotment into two
- Parking and increased traffic
- Children's safety as a result of existing park
- Vehicle speeds and speed limits
- Removal of garage on boundary and resulting security
- Asbestos removal
- Protection of the existing tree

As a result we provide the following response to the issues raised.

Two storey height

Two storey residential dwellings are noted within the Desired Character for Mid Suburban Policy Area 16 as being appropriate and there is evidence of other similar dwellings of similar form, bulk and height. This proposal for a two storey dwelling is therefore a compliant development.

Privacy and Overlooking

Concerns have been raised in relation to overlooking and privacy from upper level windows. We note that all upper level windows to the side and rear are either treated with fixed obscure glass to a height of 1.5m above floor level or set above 1.5m above floor level.

The proposal is therefore consistent with Principle of Development Control 11 of the Design and Appearance provisions of the Development Plan.

Aspex Building Designers ABN 73 090 085 037 Phone 08 8130 3700 | Fax 08 8132 1109 Level 2, 81King William Street, Kent Town South Australia 5067 www.aspexdesigners.com.au | admin@aspexdesigners.com.au building designer

Development of one single allotment into two

Two detached dwellings are being proposed and therefore there is the requirement for the land division of the existing property. Both the detached dwellings being proposed meet the minimum site area requirements (400sqm) as outlined in the table provided within the Principles of Development Control provisions of the Development Plan.

Parking and increased traffic

Concerns raised in respect to parking and increased traffic are surely not the sole concerns and responsibility of our clients. AS far as this development goes adequate on site car parking provisions have been provided both covered and uncovered. Street parking for visitors would be based on availability at the time.

Vehicle speeds and speed limits

In respect to vehicle speed, suburban roads are governed by statutory speed limits and laws and therefore would /should be enforced accordingly by the proper authority.

As with any suburban street, all drivers, whether a local resident or visitor should take the necessary precaution and responsibilities as expected whether children are present or not.

Removal of garage on boundary and resulting security

The concerns raised by Mr. Sergio Facchin in respect to the removal of the existing garage at the rear of the property can easily be eliminated by our client agreeing to notify Mr. S. Facchin prior to this outbuilding being removed. This will provide the necessary time for any security and / or privacy issues to be addressed and resolved in a satisfactory manner.

Asbestos removal

The removal of any asbestos associated with the demolition of the existing dwelling and associated structure is to be carried out by a qualified and approved contractor in strict accordance with the National Code of Practice for the Safe removal of Asbestos.

Protection of the existing tree

We confirm that the applicant will take all necessary measures and pre-cautions to protect the existing tree which Mr. and Mrs. M & R Tierney have raised as a concern.

This above mentioned tree is to remain and therefore will be protect during demolition and construction so it's immediate and future health can be maintained.

We trust the above satisfactorily responds to the key issues raised by the representors and therefore we look forward to a favorable result.

Yours faithfully,

Tibor Cseh Director Aspex Building Designers Pty Ltd

cc// Mr. Leigh Mercieca

Aspex Building Designers ABN 73 090 085 037 Phone 08 8130 3700 | Fax 08 8132 1109 Level 2, 81King William Street, Kent Town South Australia 5067 aspexbuildingdesigners.com.au | accounts@aspexbuildingdesigners.com.au

City of Charles Sturt

ATTACHMENT D

[Attachment D consists of 15 pages]

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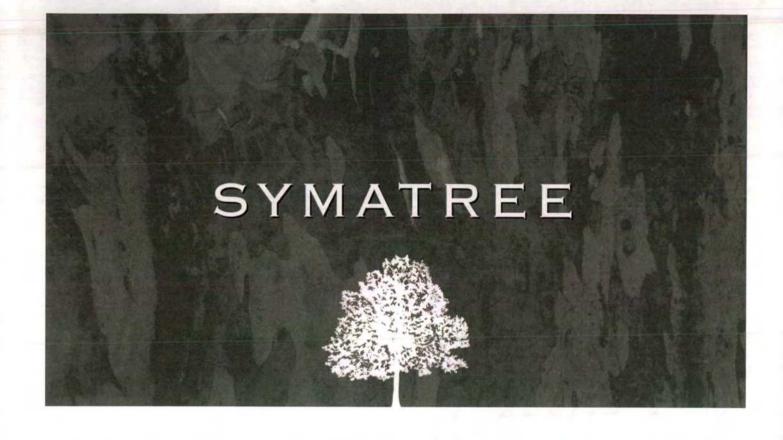
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Tree Assessment 16 Fleetwood Crescent, Henley Beach

File Number: DA 252/0167/15

Report prepared for

Leah Wojtkowski Development Officer City of Charles Sturt May 2015

Report prepared by

Sam Cassar

Cert. (Hort), Dip. (Hort), Dip. (Arb), B.App. Sc (Hort), Grad. Dip. Design (Land.)

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Introduction

Instructions

I was instructed by Council to inspect a Spotted Gum located in the rear yard of 27 Mitton Avenue. My brief was to undertake the following:

- assess the general health and structure of the tree;
- determine the potential impacts from the proposed development at 16 Fleetwood Crescent; and
- recommend appropriate action/s.

Site Visit

I carried out a site inspection on the 12 May 2015.

Documents and Information provided

Council provided copies of the following documents:

- Application form
- Plans

Limitations

This report is limited to the time and method of inspection. The tree was inspected from ground level only. Neither a climbing inspection or a below-ground investigation was performed. No soil or plant material samples were taken for laboratory analysis.

This report reflects the state of the tree as found on the day. Any changes to site conditions or surrounds, such as construction works undertaken after the inspection, may alter the findings of the report.

The inspection period to which this report applies is three months from the date of the site visit, on the basis that current site conditions remain unchanged.

Pruning requirements for the subject tree are beyond the scope of this report.

Date of Report

This report was written on the 12 May 2015.

Observations



Figure 1. Subject tree, viewed from the north-east.

Location of tree

The subject tree is located in the rear yard of 27 Mitton Avenue (Refer Figure 1). This property is located adjacent to and to the east of the proposed development site. The trunk base is 8 metres from the nearest dwelling. The trunk centre is 8.3 metres from the northern boundary fence and directly behind an adjacent shed.

The subject tree's approximate location is identified on the aerial image provided in Appendix A.

Observations (cont)

Species

Corymbia maculata, commonly known as Spotted Gum

Crown attributes (approx.)

Height: 15 metres (visual estimate)

Width (canopy extent, measured via a measuring wheel unless indicated otherwise): 5.7 metres to the east, 6.0 metres to the west (visual estimate), 7.5 metres to the north and 7.0 metres to the south.

Circumference at 1.4 metre above natural ground level

Single Trunk: 2.93 metres.

Given the tree is within 10 metres of the nearest dwelling and is not a Eucalypt or Agonis it is not subject to planning controls.

Trunk Diameter

Trunk diameter at 1.4 metres from ground: 0.88 metres.

Trunk diameter at base 1.08 metres.

Structure/Condition

The subject tree consists of a single vertical trunk to a height of approximately 2.0 metres, at which point main branching arises to form an oval shaped crown that is relatively well balanced.

The trunk appears to be sound and stable with no obvious cavities, termite or borer damage.

Tree health is considered to be good. All leaders and lateral branches are healthy and actively growing. The tree is free from notable pests and diseases. Some minor deadwood is present within the crown, the largest of which is less than 20mm in diameter.

Attachment points appear to be sound and free of any recognizable structural flaws or weaknesses that can be observed from ground. However, some sap (kino) exudate is noted from the first, second and third attachment points, northern side of the tree.

Horizontal descending branches are noted, particularly the lower to mid sections of the crown, northern side. No form of maintenance pruning appears to have occurred to this tree in the past

Observations (cont)



Figure 2. Second and third attachments, kino exudate, indicated in red.

Appraisal

The subject tree is a mature specimen, in good health with no significant structural defects that indicate it can be considered a risk to private safety at this time. The tree is expected to offer a long useful life expectancy of approximately 20 plus years under existing site conditions.

Given the subject tree is located within the neighbouring property all precautions must be taken when working within the designated TPZ, to prevent tree damaging activity occurring at and below ground level.

Tree Protection Zone

The tree protection zone (TPZ) is the principal means of protecting tree on development sites. A TPZ is required to retain the critical root zone (CRZ), protect the crown and to ensure that tree health and viability is maintained. The TPZ should be maintained for the entire life of the proposed development.

Establishment of the TPZ will mean that traditional building practices (such as standard footings) may need to be adapted. The TPZ is also calculated and applied with consideration to the possible impacts that encroachments may have on a tree's heath and long term viability.

Appraisal (cont)

Using the Australian Standard for the Protection of Tree on Development Sites (AS 4970) the following TPZ has been calculated for the subject tree:

TPZ (radius)	TPZ Area	SRZ (radius)
10.56 metres	350 m2	3.41 metres

Impacts from Development Activities

The Australian Standard for the Protection of Tree on Development Sites (AS 4970) allows encroachment into an optimum TPZ by 10% of the overall calculated area.

Based upon the plans (Aspec Building Designs, PD02 B) provided by Council it is expected an encroachment of 10.5% or 37m2 will occur. Encroachment identified for the subject tree is considered acceptable given the level identified is only slightly above what is considered allowable under AS 497 method. Spotted Gums have a moderate tolerance to root disturbance.

To reduce any impacts from the proposed development the following recommendations must be incorporated in the development of the site and adhered to at all time:

- All existing underground service (i.e. water, gas, sewer electrical) must be reused or if new service installations are required they must be installed along the southern boundary. Any excavation carried out within the TPZ of the subject tree must occur using non-destructive excavation techniques such as Hand digging, Air-Spade, HydroVac under the supervision of an Arborist (level 5 or greater).
- Paving is to be installed on natural ground level using tree sensitive construction measures. Paving used must be a semi-permeable/porous pavement type such as interlocking brick pavers (e.g. Eco-pave or similar) or coarse gravel at least to the TPZ specified.
- Building storage and wash out areas are to be located outside the designated TPZ area of the subject tree.

To reduce any impacts from the proposed development further protection measures and construction details have been specified in a tree protection plan refer **Attachment B**. These measures must be adhered to at all times.

No specific canopy management is required to allow for the proposed development to proceed.

Conclusion

The subject tree is in good health and has no significant structural defects that indicate it can be considered a risk to private safety.

Given the subject tree is located within the rear yard of the neighbouring property it should be retained and protected from any adverse impacts from the proposed development.

No adverse impacts from the proposed development are expected. Tree sensitive construction methods are available to reduce any potential adverse impacts from the proposed development. These measures have been specified in **Attachment B**. These measures must be adhered to at all times. These measures should be incorporated as conditions of approval.

Thank you for the opportunity to provide this report. If you have any questions or require further information, please do not hesitate to contact me.

V Co

Sam Cassar

Appendix A Aerial Image



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Appendix B Tree Protection Plan

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Tree Protection Plan

Tree Protection Zone (TPZ)

The calculated Tree Protection Zone (TPZ), for the subject tree is measured from the centre of the respective tree in all directions. A TPZ is required to protect the critical root zone and to ensure that tree health and stability is maintained. The TPZ should be maintained for the entire life of the proposed development. The following TPZ for the subject tree have been calculated:

TPZ (radius)	TPZ Area	SRZ (radius)
10.56 metres	350 m2	3.41 metres

Establishment of the TPZ will mean that traditional building practices (such as trenched footings) will need to be adapted.

Contractors and trade staff must be informed by the site supervisor and project arborist to take precautions when working within the designated TPZ, to prevent tree damaging activity occurring at and below ground level.

Protective Fencing

Access to the designated TPZ must be controlled via the erection of fencing. Given site constraints and construction activities however, it does not appear that it will be possible to fence the complete recommended TPZ for the subject tree. Fences required should be erected at 5 metres respectively on all sides' development is proposed, this is in combination with existing boundary fencing.

The protective fencing must be erected prior to works commencing on site. The fencing should consist of 2.0 metre high, solid chain-mesh, steel or similar fabrication with posts at 3 metre intervals. The fence should incorporate on all sides, a clearly legible sign displaying the words "Tree Protection Zone".

If a smaller fenced protection zones (to that recommended) need to be used, an assessment should be made as to the likely adverse impacts on tree health and stability. In such cases, assessment should be undertaken by a qualified arborist.

Access to, or work inside the TPZs, requires the prior approval of the project arborist and Council. Fences should be maintained until the dwelling has been completed. Fences can then be removed to allow paving and landscaping to proceed.

Storage and Washout Area

 A defined storage area for building materials and hazardous chemicals and a wash out area should be marked outside the TPZ area

Underground Services (If Required)

The following should guide underground service installation:

 Installation of new underground services within the TPZ only non invasive methods, such as directional boring, air spade, hydro vac or hand digging should be used (refer below for various methods). Trenching by machinery should not be used under any circumstances. • Manual excavation should be carried out under the supervision of the project arborist to identify roots critical to tree stability.

Directional Boring

- All entry and exit points for drilling equipment must be located outside the designated TPZ. If site constraints require these structures to be within the designated TPZ then consultation with the project arborist and council approval is required.
- All inspection points, sumps, inverts, directional changing elbows must be placed outside the TPZ where possible. If site constraints require these structures to be within the designated TPZ then consultation with the project arborist and council approval is required. The project arborist should assess the likely impacts of boring and bore pits on retained tree/s.
- The directional drilling bore should be at least 1 metre or greater below natural ground within designated TPZ to ensure the bulk of tree roots are missed.

Air Spade/Hand Digging

- Excavation should use a combination of hand digging and air spade down to the required depth for the entire length within the designated TPZ.
- All structural roots, (roots with a diameter greater than 30 millimetres), encountered within or outside of the recommended TPZ, should be retained.
- Insert pipe conduits into the trench by weaving between exposed roots.
- Backfill the excavation as soon as possible, and water the soil around the roots, to avoid leaving air pockets.
- Where roots within the designated TPZ are exposed by excavation, temporary root protection should be
 installed to prevent them drying out. This may include jute mesh or hessian sheeting as multiple layers
 over exposed roots and excavated soil profile, extending to the full depth of the root zone. Root protection
 sheeting should be pegged in place and kept moist during the period that the root zone is exposed.

General Protection Measures

The following measures should be adhered to within the designated TPZ of the subject tree at all times:

- All works encroaching into the TPZ of the subject tree must be undertaken carefully and completed with hand-tools, no machinery.
- No servicing and/or refuelling of equipment and/or vehicles should occur within the TPZ.
- No activity involving or using fuel, oil or chemicals should be conducted within the TPZ
- No storage of material, building rubble, construction materials, equipment or temporary buildings/structures should be allowed within the TPZ.
- No additional excavating or digging of any form, unless specified, should occur within the TPZ.
- No placement of additional soil within or removal of soil from, the TPZ should occur, unless specified.
- Scaffold supports required within the TPZ are to be placed on planks or boards of a suitable thickness.

• No changes to natural ground level within the TPZ should be made (except those specified).

Paved Areas

Traditional paving works often requires excavation, soil compaction, changes in soil levels and the installation of impervious surfaces. These actions all will have an adverse impact on health of the soil and the tree's root system which in turn will adversely impact tree health.

Paving within the designated TPZ for the subject tree for paved areas/paths particularly around the pool must be constructed as follows:

- Do not allow grade changes to occur in the designated TPZ of the subject tree. The soil surface should be carefully skimmed to establish the base for new paved surfaces. Adjust finish grades so that the paving sections are built on the natural grade. Remove weeds/undesirable garden plants or excessive soil carefully to avoid damage to surface roots. These works should only be carried out by hand.
- Where roots within the designated TPZ are exposed by excavation, temporary root protection should be installed to prevent them drying out. This may include jute mesh or hessian sheeting as multiple layers over exposed roots and excavated soil profile, extending to the full depth of the root zone. Root protection sheeting should be pegged in place and kept moist during the period that the root zone is exposed.
- All structural roots, (roots with a diameter greater than 30 mm), encountered within the recommended TPZ, should be retained if possible. Roots small than 30 mm that require pruning must be done using a sharp pruning saw or secateurs. Roots with diameters greater than 30 mm should only be pruned in consultation with the project arborist.
- To protect the natural soil structure excessive compaction should be avoided. Compaction is not normally necessary for pedestrian or light traffic.
- Reduce the sub-base compaction requirements by placing a geotextile fabric at the bottom of the pavement section to protect it from displacement into the soft natural soil, preventing different layers from mixing. They also assist in preventing tree roots from growing up into the sub base if a fine grade fabric is used. Geotextile fabrics also allow air and water exchange.
- Level surfaces should be established above the existing natural ground level (and geotextile fabric) using a porous sub base material such as a structural soil such as SPACE (structurally permeable aerated compactable earth). These materials can be compacted and will still allow air and water exchange. The sub base material should be selected to suit the anticipated use and loading. There should be no fine particles in the mix.
- A geotextile fabric should be placed over the sub base, preventing different layers from mixing, blocking pore spaces.
- The bedding layer and between the pavers should use a graded aggregate between 5 7 mm, providing good drainage and adequate air movement.
- Use a semi-permeable/porous pavement type such as interlocking brick pavers (eg. Eco-pave or similar) or coarse gravel at least to the TPZ specified. Semi-permeable pavement types and coarse gravels will allow some air and water infiltration through the surface.
- All works encroaching into the TPZ of the subject tree must be undertaken by hand, no machinery.

• Collaboration may be required between the project arborist and the geotechnical or structural engineer.

Post Construction

The following should be adhered to after the development is complete:

- Take all reasonable measures and precautions to protect the subject tree once development of the site has been completed.
- All new boundary fences, if required within the subject tree's TPZ, should be of 'post and rail' construction. Post holes required will present some minor disturbance to the tree's root system. Therefore post holes should be dug by hand if they are required within the designated TPZ. They should be relocated if structural roots (roots with a diameter greater than 30 mm) are encountered.

Tree Inspections

• An assessment of tree health, stability and management requirements every two to three years, subject to the growth rate of the tree, is also recommended.

Canopy Management

• Specific pruning requirement for the subject tree is beyond the scope of this report. Permission from the tree owner must be obtained before any pruning can be implemented to allow for the proposed development to proceed.

[Attachment E consists of 1 page]

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ATTACHMENT E

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