OFFICE USE ONLY Date Filed: 02/08/6 Amount/Fee: 600 Receipt No: Received By: 30 Days: Deemed Incomplete: Deemed Complete: 120 Day Deadline:	LAND USE APPLICATION	FILE No: SPR 2016—0						
APPLICATION TYPE								
ANNEXATION	LOT LINE ADJUSTMENT	SITE PLAN REVIEW						
APPEAL OF PLANNING COMMISSION DECISION	MINOR PARTITION	SUBDIVISION						
APPEAL OF PLANNING DEPARTMENT DECISION	NATURAL RESOURCE DEVELOPMENT REVIEW	URBAN GROWTH BOUNDARY AMENDMENT						
COMPREHENSIVE PLAN & ZONING MAP AMENDMENT	NATURAL RESOURCE DEVELOPMENT VARIANCE	VACATION						
COMPREHENSIVE PLAN &/OR ZONING ORDINANCE TEXT AMENDMENT	PLANNED UNIT DEVELOPMENT PRELIMINARY MASTER PLAN	Variance						
CONDITIONAL USE PERMIT	PLANNED UNIT DEVELOPMENT FINAL MASTER PLAN	OTHER						
NAME OF APPLICANT: Douglas Struck and  MAILING ADDRESS: POBa 480  CITY: Neotsu STATE: OR, ZIP: 97364  DAYTIME PHONE: 5-41 92(1600 Signature: Si								
OWNER OF RECORD (if other than								
NAME:	Same	Si .						
CITY:	<del>-</del>	ZIP:						
DAYTIME PHONE:								
□ AGENT, □ FEE OWNER, □ CO PROJECT LOCATION: □ 2:  PROJECT ADDRESS:	NTEREST IN PROPERTY SUBJECT TO NTRACT PURCHASER, ロOPTION HO 850 ルミ Hwy 101	Lincoln City						
ASSESSOR'S MAP NO .:	11-11-BB TAX LOT(S):	01100						

AREA:

(acres)

SQ. FT.:


ZONING:




## SITE PLAN REVIEW EVIDENCE TO SUPPORT OF FINDINGS OF FACT



PROJECT DESCRIPTION	
Describe the project including the type of use, number existing and proposed buildings, etc. Attach sheets if	per of dwellings, square footage of necessary.
New wood frame	4 plan and
one office space. 3	420 SF Total
For 4- Place and a	288 CF 504
are constitution	may to make
- oma spage. Ifis	project replace
a tear down of a	V old Single
tanily residence.	
APPLICANT'S VERIFICATION	
I (We) hereby declare under penalty of perjury under	er the laws of the State of Oregon
that the information in this application and its attachm	
SIGNATURES	
(/h//	2011
Applicant	2-8-16
ADDICADIV	Data
	Date
Doyla Sth	2 - 8 - 16
Property Owner	Date 2 8 - 16 Date
Doyla Sth	2 - 8 - 16
Doyla Sth	2 - 8 - 16

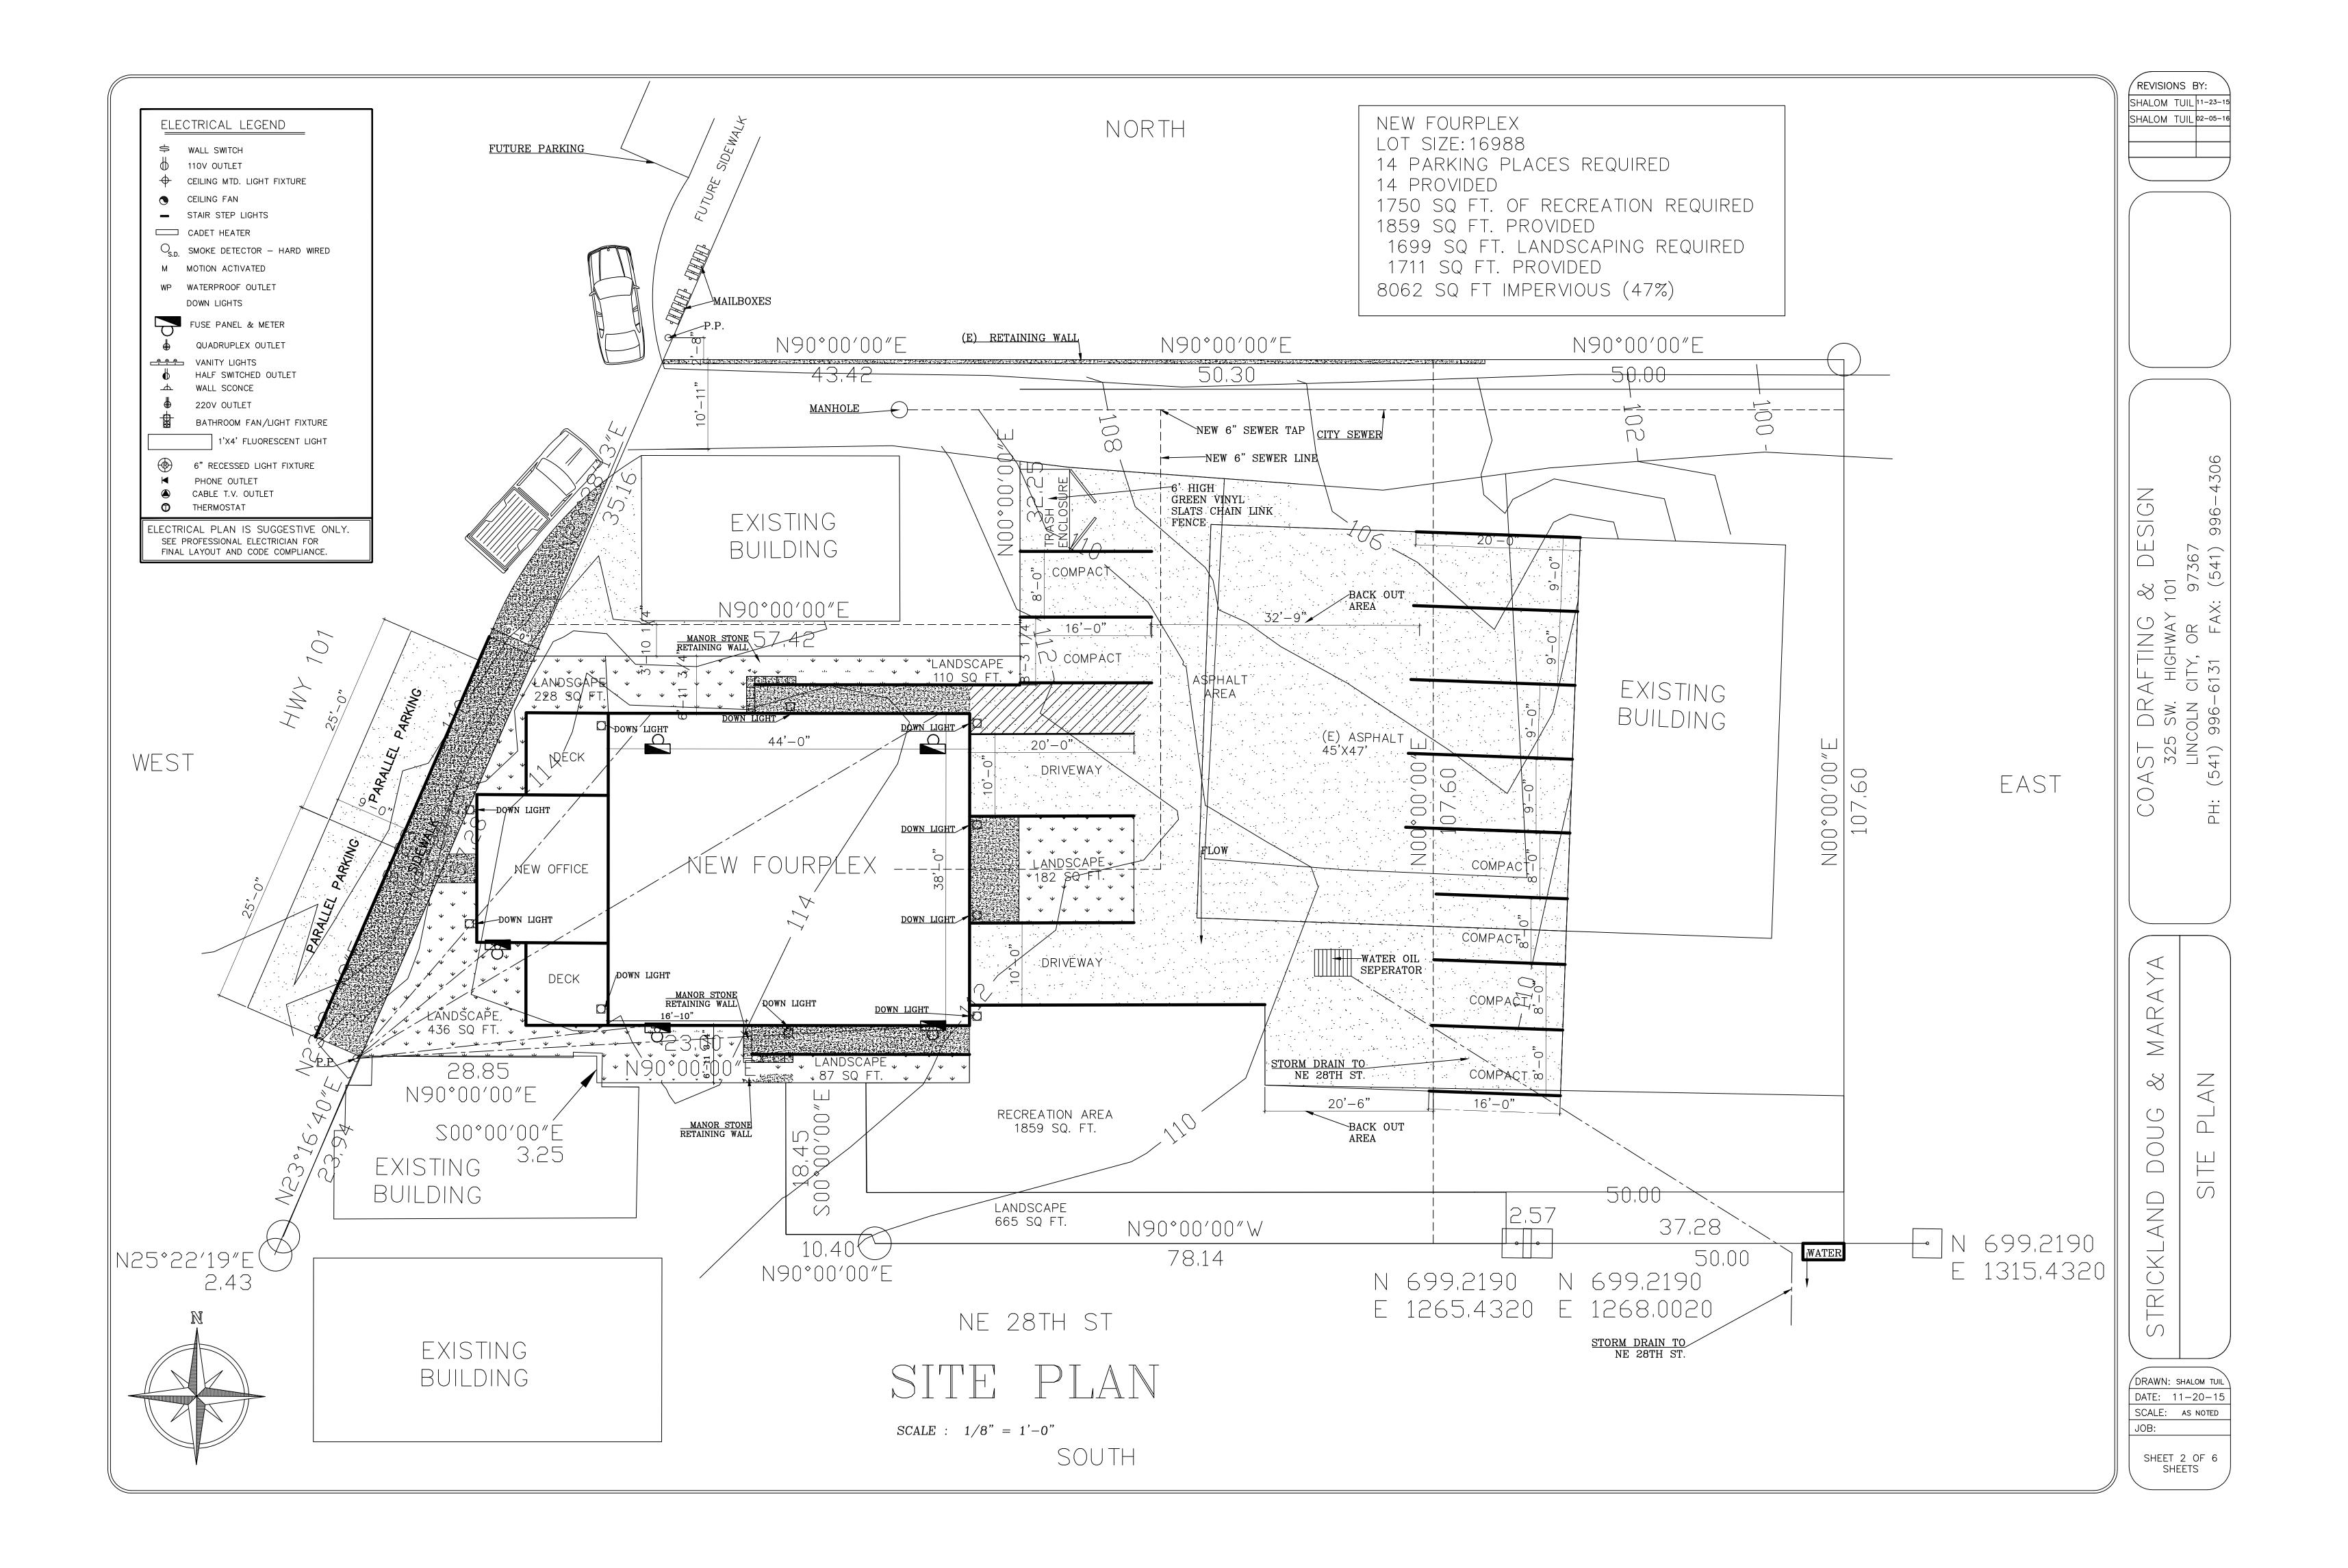

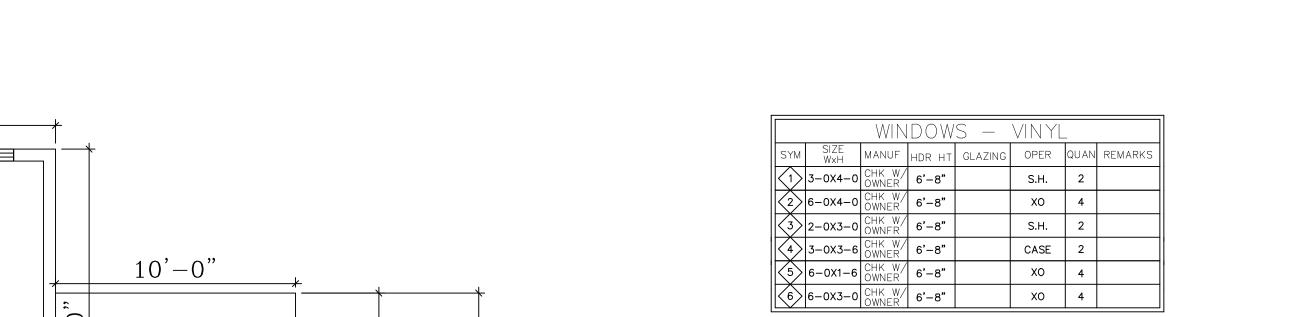

WEST

10'-0"

WATERPROOF

FRIDGE

18'-9"

DECK

0,

34'-0"

-8,

18'-0"

COMMERCIAL OFFICE

10'-0"

WATERPROOF

DECK

BAR TOP

19'-3"

38'-0"

EAST

0,

-6"

13,

50,-0,"

SOUTH

	DOORS										
SYM	SIZE W x H	CORE	MAT	HRDWRE	FINISH	QUAN	REMARKS				
(A)	3-0X6-8	S.C.	CHK W/ OWNER	L.H	CHK W/ OWNER	2	D.BORE				
В	3-0X6-8	S.C.	CHK W/ OWNER	R.H.	CHK W/ OWNER	2	20 MIN				
$\bigcirc$	9-0X7-0	S.C.	CHK W/ OWNER	GARAGE	CHK W/ OWNER	2	D.BORE				
	2-4X6-8	S.C.	CHK W/ OWNER	R.H.	CHK W/ OWNER	4	D.BORE				
(E)	2-4X6-8	S.C.	CHK W/ OWNER	L.H	CHK W/ OWNER	4	D.BORE				
(F)	2-8X6-8	S.C.	CHK W/ OWNER	R.H.	CHK W/ OWNER	3	D.BORE				
G	2-8X6-8	S.C.	CHK W/ OWNER	L.H	CHK W/ OWNER	3	S.BORE				
G	2-4X6-8	S.C.	CHK W/ OWNER	POCKET DOOR	CHK W/ OWNER	3	S.BORE				

S.H. 2 CASE 2

XO 4 XO 4

	DOORS									
SYM	SIZE W × H	CORE	MAT	HRDWRE	FINISH	QUAN	REMARK			
$\bigcirc$	3-0X6-8	S.C.	CHK W/ OWNER	L.H	CHK W/ OWNER	2	D.BORE			
$\bigcirc$ B	3-0X6-8	S.C.	CHK W/ OWNER	R.H.	CHK W/ OWNER	2	20 MIN			
$\bigcirc$	9-0X7-0	S.C.	CHK W/ OWNER	GARAGE	CHK W/ OWNER	2	D.BORE			
D	2-4X6-8	S.C.	CHK W/ OWNER	R.H.	CHK W/ OWNER	4	D.BORE			
(E)	2-4X6-8	S.C.	CHK W/ OWNER	L.H	CHK W/ OWNER	4	D.BORE			
F	2-8X6-8	S.C.	CHK W/ OWNER	R.H.	CHK W/ OWNER	3	D.BORE			
G	2-8X6-8	S.C.	CHK W/ OWNER	L.H	CHK W/ OWNER	3	S.BORE			
(G)	2-4X6-8	S.C.	CHK W/ OWNER	POCKET DOOR	CHK W/ OWNER	3	S.BORE			

NORTH

2ND FLOOR FLOOR PLAN

SCALE: 1/4" = 1'-0"

2ND FLOOR=646 SQ FT 3RD FLOOR=646 SQ FT TOTAL PER UNIT=1292 SQ FT DESIGN

REVISIONS BY:

S.TUIL 11-23-15 S.TUIL 02-05-16

MARAYA OORPLAN  $\approx$ FLOOR STRICKLAND  $\sum_{N}$ 

DRAWN: SHALOM TUIL SCALE: AS NOTED

SHEET 5 OF 6 SHEETS

		WIN	IDOW	S -	VINYL	_	
SYM	SIZE WxH	MANUF	HDR HT	GLAZING	OPER	QUAN	REMARKS
$\overline{\langle 1 \rangle}$	6-0X6-10	CHK W/ OWNER	6'-8"		SLIDER	2	
$\langle 2 \rangle$	6-0X4-0	CHK W/ OWNER	6'-8"		хо	6	
3	2-0X3-0	CHK W/ OWNFR	6'-8"		S.H.	2	
4	2-0X3-0	CHK W/ OWNER	6'-8"		CASE	2	
<u>(5)</u>	6-0X1-6	CHK W/ OWNER	6'-8"		хо	4	
6	6-0X3-0	CHK W/ OWNER	6'-8"		хо	2	

			D(	OORS			
SYM	SIZE W x H	CORE	D(	OORS HRDWRE	FINISH	QUAN	REMARKS
SYM (A)	SIZE W × H 3-0X6-8	CORE S.C.	CHK W/		CHK W/	QUAN 2	
	W×H			HRDWRE			REMARKS D.BORE 20 MIN

SOUTH SOUTH STREAM

AND STREAM

BATHROOM

18'-0'XII'-0'X 14'-0'XII'-0'XI

EAST

3RD FLOOR FLOOR PLAN

SCALE: 1/4" = 1'-0"

2ND FLOOR=646 SQ FT

3RD FLOOR=646 SQ FT

TOTAL PER UNIT=1292 SQ FT

STRICKLAND DOUG & MARAYA 3RD FLOOR FLOORPLAN

REVISIONS BY:

S.TUIL 11-23-15 S.TUIL 02-05-16

996-4306

DESIGN

COAST DRAFTING & DES 325 SW. HIGHWAY 101 LINCOLN CITY, OR 97367 'H: (541) 996-6131 FAX: (541) 9


DRAWN: SHALOM TUIL DATE:

SCALE: AS NOTED

JOB:

SHEET 6 OF 6 SHEETS

WINDOWS — VINYL								
SYM	SIZE WxH	MANUF	HDR HT	GLAZING	OPER	QUAN	REMARKS	
$\bigcirc$	3-0X5-0	CHK W/ OWNER	6'-8"		S.H.	3		
$\langle 2 \rangle$	6-0X4-0	CHK W/ OWNER	6'-8"		хо	6		
3	2-0X3-0	CHK W/ OWNFR	6'-8"		S.H.	2		
4	3-0X3-6	CHK W/ OWNER	6'-8"		CASE	4		
5	6-0X1-6	CHK W/ OWNER	6'-8"		хо	4		
6	6-0X3-0	CHK W/ OWNER	6'-8"		хо	4		

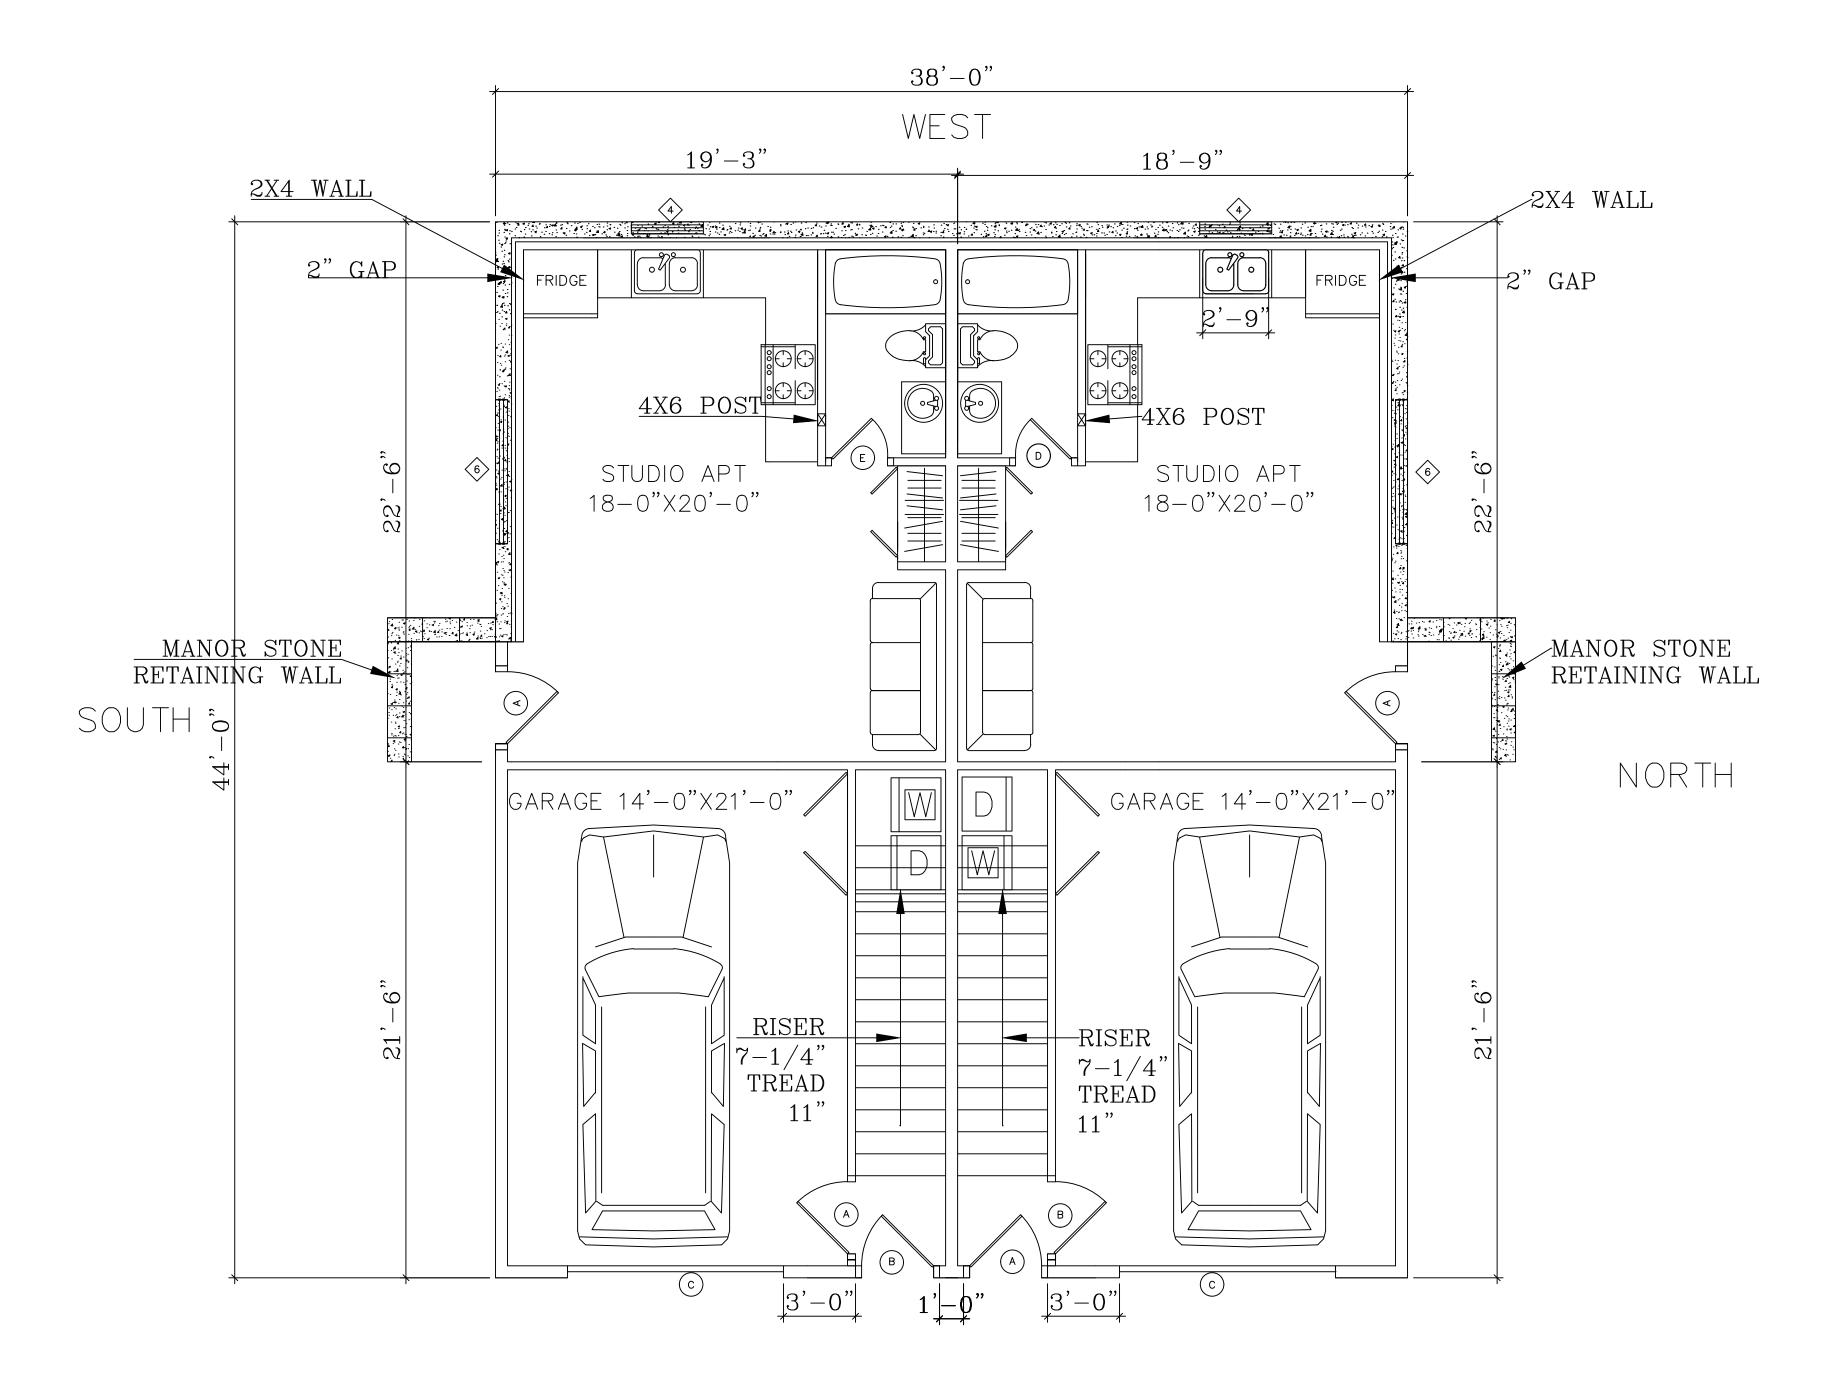

	DOORS										
SYM	SIZE W x H	CORE	MAT	HRDWRE	FINISH	QUAN	REMARKS				
(A)	3-0X6-8	S.C.	CHK W/ OWNER	L.H	CHK W/ OWNER	2	D.BORE				
В	3-0X6-8	S.C.	CHK W/ OWNER	R.H.	CHK W/ OWNER	2	20 MIN				
	9-0X7-0	S.C.	CHK W/ OWNER	GARAGE	CHK W/ OWNER	2	D.BORE				
(D)	2-4X6-8	S.C.	CHK W/ OWNER	R.H.	CHK W/ OWNER	4	D.BORE				
E	2-4X6-8	S.C.	CHK W/ OWNER	L.H	CHK W/ OWNER	4	D.BORE				
F	2-8X6-8	S.C.	CHK W/ OWNER	R.H.	CHK W/ OWNER	3	D.BORE				
G	2-8X6-8	S.C.	CHK W/ OWNER	L.H	CHK W/ OWNER	3	S.BORE				
G	2-4X6-8	S.C.	CHK W/ OWNER	POCKET DOOR	CHK W/ OWNER	3	S.BORE				

EAST

SCALE: 1/4" = 1'-0"

STUDIO=418 SQ FT.

COAST DRAFIING & DES 325 SW. HIGHWAY 101

STRICKLAND DOUG & MARAYA

GARAGE

DRAWN: SHALOM TUIL

DATE:

SCALE: AS NOTED

SHEET 4 OF 6
SHEETS

#### GENERAL NOTES

These plans were designed to conform to the latest edition of the Uniform Building Code at the time the plans were drawn. Constant changes in building codes, both locally and nationally, in addition to changes in environmental qualifications and local options for plumbing, heating/cooling and wiring, make conformity to all building restrictions impossible. Consequently, the use of these plans is subject to local code requirements and interpretations. It is the responsibility of the user to evaluate these plans for conformity to local code requirements. Any additional design or drawing services required by local code are subject to Coast Drafting & Design standard service fees.

The Contractor shall verify all dimensions and conditions prior to beginning any work and notify owner of any discrepancies.

Written dimensions shall take precedence over scaled dimensions. DO NOT SCALE DRAWINGS.

Coast Drafting & Design does not guarantee the availability of any manufactured product suggested or specified on the plans or specifications. The builder is advised to verify the availability of all manufactured products before proceeding with construction, especially those items affecting rough opening dimensions or other dimensions on the plans. All manufactured materials, components, fasteners, assemblies, etc., shall be handled and installed in conformance with manufacturers specifications and instructions. Where specific products are called for, generic equivalents which meet applicable standards and specifications may be used.

In event of a conflict between applicable codes and regulations, and reference standards of these plans and specifications, the more stringent provisions shall govern.

No variation required by a Building Official shall be binding on the Designer.

Specifications and drawings indicate finished structure. Builder shall be responsible for construction methods, procedures and conditions except as specifically indicated otherwise in contract documents.

No amendments or modifications to these documents or the building they represent shall be made without the consent of the owner and Coast Drafting & Design.

Any discrepancies shall be brought to the immediate attention of Coast Drafting & Design.

All drawings and designs are to remain the sole property of Coast Drafting & Design. Any use of these drawings other than the one contracted is expressly prohibited.

### FOUNDATIONS:

- Footings shall bear on firm, undisturbed soil a minimum of 6" below the finish grade line and 8" below the line of the original grade for one and two story structures, and 12" below finish grade for three—story structures, unless otherwise noted.
- 2. Foundation and footing sizes are based on a maximum allowable soil bearing pressure of 1500psf. Verify local conditions and notify owner of any discrepancy.
- 3. Do not excavate greater than a 2:1 slope below footings.
  4. Footings to extend below frost line or 18" below finish grade, whichever is greater.

#### CONCRETE:

- All foundation wall and footing concrete shall develop a minimum compressive strength of 2500 psf @ 28 days.
- 2. All concrete slabs shall develop a minimum compressive strength of 2500psf at 28 days.

  Concrete forms, sharing and pouring methods shall conform to current ACL standards.
- 3. Concrete forms, shoring and pouring methods shall conform to current A.C.I. standards.4. Apply "PARASEAL" or equal foundation coating on all exterior faces of walls below grade.

### REINFORCING STEEL

- All reinforcing steel shall be deformed steel bars conforming to ASTM A615, GRADE 40.
   All reinforcing steel shall be manufactured, detailed, fabricated and placed in accordance with ACI 318R,
- ACI 315R, AND ACI SP 66.

  3. Welded wire fabric shall conform to ASTM A185, in as long a length as is practical. Welded wire
- fabric shall be lapped at least one grid width plus 2".
  4. Reinforcement shall be bent cold and shall not be welded.
- 5. Splices:

  Reinforcement in concrete and masonry shall have lap lengths as follows,

unless otherwise specified on drawings.

Bar Size In Concrete: In Masonry:

#3 1'-6" 2'-0"

#3 1'-6" 2'-0" #4 2'-0" 2'-6" #5 2'-6" 3'-0"

- 6. Reinforcement shall be accurately placed and supported by concrete, metal or other approved chairs, spacers, or ties and secure against displacement during concrete or grout placement.
- 7. Except where otherwise noted, reinforcement shall have concrete cover as follows:

  1. Concrete deposited against earth 3"
  - 2. Formed concrete against earth3. Exterior faces of walls2"
  - 4. Interior faces of walls
    5. To top of slab-on-grade
    3/4"
- WOOD FRAMING:

All solid sawn lumber shall be Douglas Fir / Larch, installed as noted on the plans and connected as specified in nailing schedule below. Lumber shall be as graded in accordance with current Western Wood Products Association [WWPA] standard grading rules. Lumber grades for uses to be:

Products Association [WWPA] standard grading rules. Lumber grades for us
A. Posts, Beams & Headers #2 or better
B. Floor, Ceiling Joists, & Rafters #2 or better

C. Sills, Plates & Blocking

B. Studs

D. F. "stud" ( 6" exterior & 4" interior U.O.N.)

E. 2" T&G Sub-Floor Decking

F. Wall & Roof Sheathing

#3

D.F. "stud" ( 6" exterior & 4" interior U.O.N.)

1/2" C-D ext. glue

Plywood 32/16

G. Sub-Floor over Joists

H. Glu-Laminated Beams
A.I.T.C. Industrial Grade with dry use adhesive.

(Wet use adhesive for exterior use)

3/4" underlayment grade plywood (Ext.)

FB =2,000 psi

FV =165 psi

E =1,800,000 psi

Solid sawn lumber at visually exposed locations shall be #2 & better grade. All exterior wall & interior bearing wall openings shall have 4 x 10 #2 D.F. headers unless otherwise noted.

### INSULATION:

DESIGN LOADS

DEAD LOADS: Vaulted Areas are Under 50% R-30 Roof, with shakes/shingles 15 psf Flat Ceilings & over 50% Vaulted R-38 Roof, with clay/concrete tiles 25 psf Exterior Walls 2x6 Studs Floor 10 psf Floors over unheated spaces R-30 LIVE LOADS: Basement walls R-21 RIGID R-15 Slab floor edge insulation Forced air duct insulation Stairs 100 psf Cantilevered floor & floors over garages R-30 Decks 60 psf Windows: 50 psf or 2000 pt.ld. U = 0.4020 psf Skylights <2%

Doors other than main entry U= 0.20 Main entry door, Maximum 24 sq. ft.

U = 0.50

### NAILING SCHEDULE:

CONNECTION: NAILING: Joist to Sill or Beam (3) 8d Toe Nailed or (2) 16d Bridging to joists (2) 8d Toe Nailed Ea. End 2" T&G Decking/Sub-Floor to Beams (2) 16d Toe Nail Thru Tongue (3) 16d Face Nailed Rim Joist to Joists 16d Face Nailed Ea. End Studs to sole plate 16d at 16" o.c. Face Nailed Sole Plate to Joists or Blocking Sole Plate or Top Plate to Studs 16d Face Nailed Double Top Plate 16d at 16" o.c. Face Nailed 16d at 24" o.c. Face Nailed Double Studs 16d at 24" o.c. Face Nailed Corner Studs Top Plates At Laps & Intersection 16d Face Nailed 16d at 16" o.c. Face Nailed Headers to Top Plates 8d Toe Nailed or (2) 16d Ceiling Joists to Plates (3) 16d Face Nailed Joist Laps over Partitions Ceiling Joists to Plates (3) 16d Face Nailed Rafters to Top Plate (3) 8d Toe Nailed with "Simpson"

### NAILING SCHEDULE NOTES:

A. All frame walls shall have stud framing placed at 16"o.c. except where

H-2.5 Connectors-Verify

(1) 8d Common at 6" o.c. at edges

(1) 8d Common at 6" o.c. at edges

& 12" o.c. in field

& 12" o.c. in field

- B. Top plates shall be doubled on all walls except where otherwise noted.

  C. Trimmers under all headers shall be continuous to sole plate.
- D. Block all stud walls as required for sheathing.

  E. Beams, girders and joists supporting bearing walls or concentrated
- loads shall not be notched.

  F. All joists shall have a minimum of 1-3/4" bearing @ supports.

  G. Lap all joists a minimum of 6" each way @ all interior bearing supports.

  H. Mud sills and ledger boards at concrete walls shall have anchor bolts of the size and spacing shown on the drawing. Each board shall be
- secured with at least two bolts and each board shall have a bolt within 12" of each end.

  I. Cover surfaces behind siding, shingles and where indicated on drawings with 15# felt, or and approved equivalent product.

  J. Provide framing at all roof & floor diaphragm penetrations

# MISCELLANEOUS:

unless otherwise noted on plans.

Plywood Sub-Floor to joists

Plywood Wall & Roof Sheathing

- A. Contractor shall verify all conditions and dimensions prior to beginning work and shall notify owner of any discrepancy.
- B. Contractor shall be responsible for any variations or deviations from the plans without written confirmation from Designer.
- C. Contractor shall provide adequate bracing or otherwise support all portions of the structure until all members have been permanently
- connected together. D. Plumbing diagrams or drawings shall be provided by the plumbing
- E. Heating/Cooling duct diagrams or drawings shall be provided by the heating/cooling contractor.
- F. Heat loss or energy use calculations shall be provided by heating cooling contractor or other professional as required by Building Official.
  G. Truss design, engineering and plans shall be provided by truss manufacturer.
- H. Each bedroom shall have at least one window with a sill height of no more than 44" above the floor.
  I. Smoke detectors shall be connected to house power, in series.
- J. Tub and tub/shower enclosures to have 1/2" water resistant gypsum board and a hard, moisture resistant surface up to 6'-0" above floor (min.)

  K. All exhaust fans,range hoods and dryers shall vent to the outside through sheet metal ducts. Caulk around all penetrations through
- exterior envelope.

  L. All windows, patio doors and doors with glass shall be double glazed insulating units with wood or thermally broken aluminum frames and sashes.
- M. All glass within 24" of a door and/or within 18" of the floor or a walkway shall have tempered glazing.
- N. All wood in permanent contact with concrete or soil shall be pressure treated with a water bourne preservative.
- O. All exterior walls & walls common to unheated spaces shall be 2x6 studs @ 16" o.c. with R-21 insulation unless otherwise noted on the plans.
   P. All interior walls shall be 2x4 studs @ 16" o.c. U.O.N.
- Q. Provide 1 hr. fire wall between garage and living areas, and under all stairs where storage space is available.
- R. All doors between garage and living areas shall be 20 min. fire rated assemblies with 1-3/4" solid core wood doors or code approved
- equivalents and self-closing mechanisms.

  S. Please call this office at (541) 996-6131 for any questions relating

### to these plans.

### OWNER INFORMATION:

DOUG & MARAYA STRICKLAND P.O. BOX 480

NEOTSU, OR 97364


### SITE INFORMATION:


MAP: 07-11-11-BB
TAX LOT: 01100
ADDRESS: 2852 NE HWY 101
LINCOLN CITY, OR 97367
TOTAL LOT: 16,988 SQ FT.

BUILDING AREA: 1960 SQ FT

LOT COVERAGE: 10%

AVE. BUILDING HEIGHT: 33-'6"

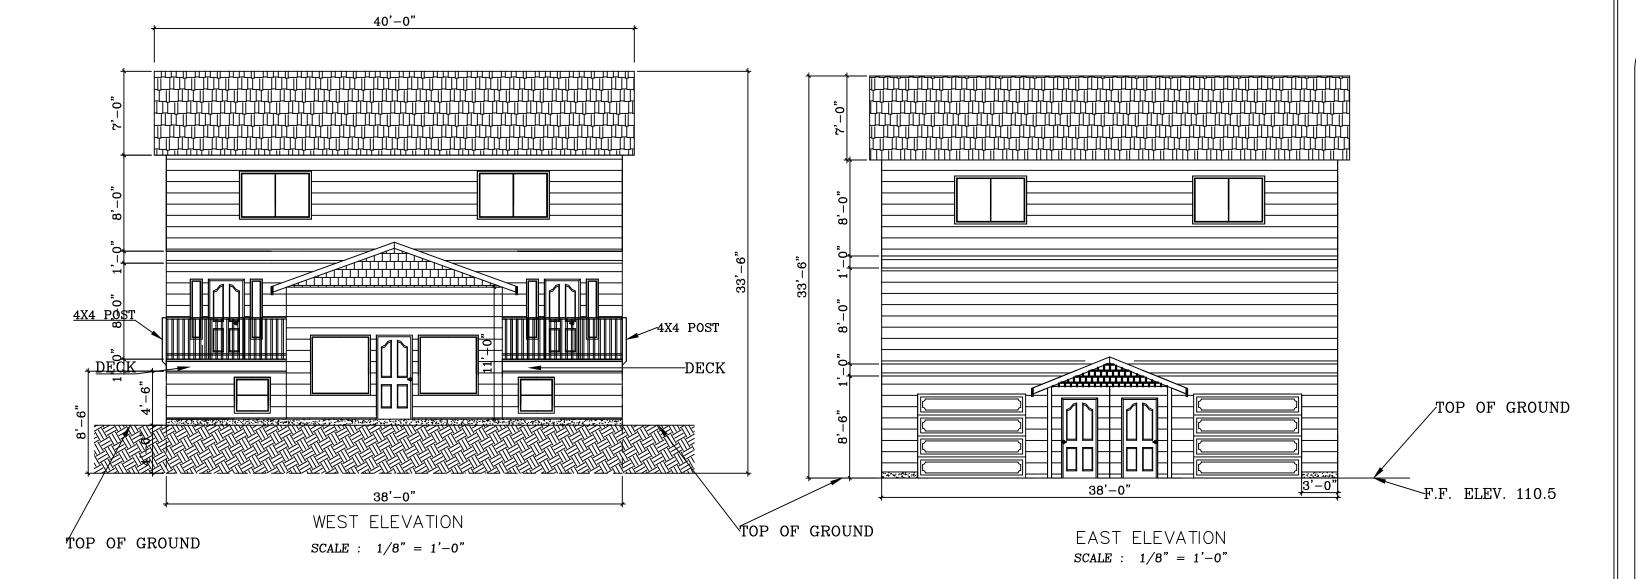

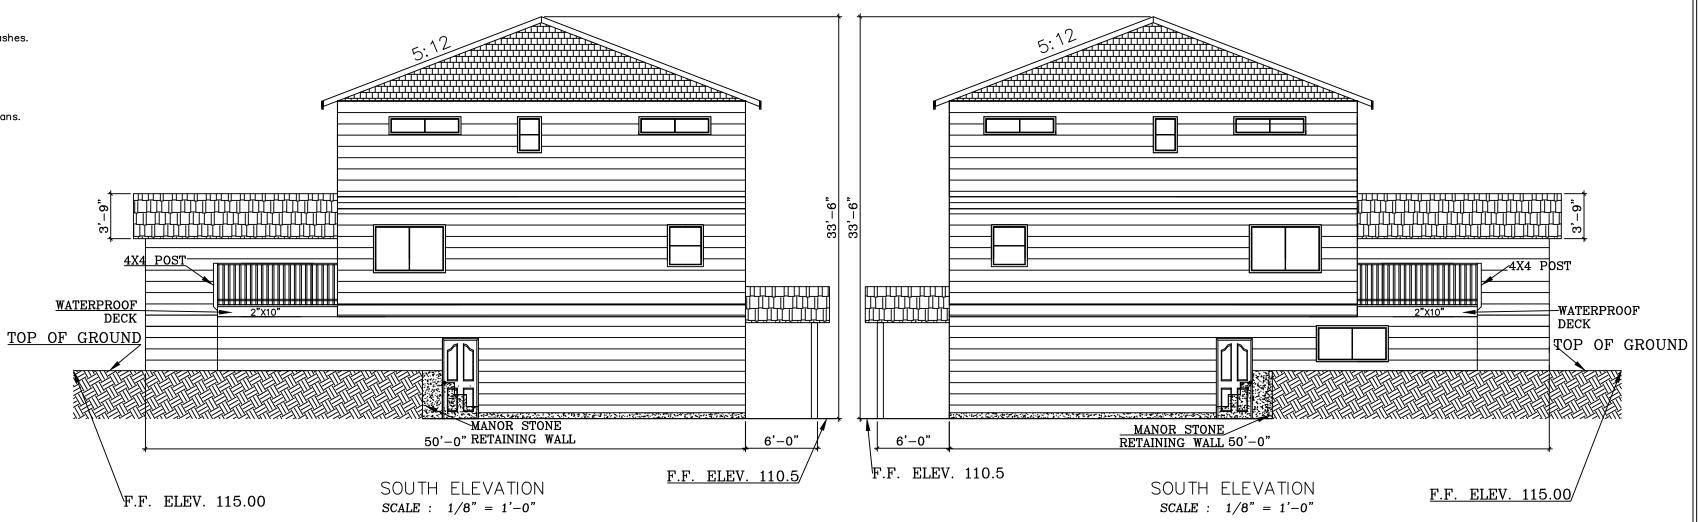

SCALE: 1/8" = 1'-0"

COAST DRAFTING & DESIGN 325 SW. HIGHWAY 101 LINCOLN CITY, OR 97367 PH: (541) 996-6131 FAX: (541) 996-

REVISIONS BY:

SHALOM TUIL 11-23-1

SHALOM TUIL 02-05-1

CKLAND DOUG & MARAY

DRAWN: SHALOM TUIL
DATE: 11/20/2015
SCALE: AS NOTED

SHEET 1 OF 6 SHEETS

JOB:

